FOR QUESTIONS, CALL THE International Sales Office REGION 20 PHDNE: (647) 977 - 2217 EMAIL: reg20@captiveaire.com

KH-2 CAPTRATE SOLO FILTER 3

<u>WALL-MOUNT UTILITY CABINET</u>

WALL MNT | 12"×30"×24"

| WALL MNT | 12"×30"×24"

SIZE

LOCATION

RISER SENSOR INSTALL 6IN PLEN.

RISER SENSOR INSTALL 6IN PLEN.

TYPE

TANK FS

TANK FS

HOOD OPTIONS

TAG

<u>HOOD INFORMATION - JOB#717</u>9537 APPLIANCE DESIGN | TOTAL END TO ROW TAG MANUFACTURER LENGTH COOKING DUTY |CFM/FT|EXH CFM| CONSTRUCTION WIDTH LENG HEIGHT DIA CFM VEL TEMP END 600 DEG 430 SS 817 | 1634 | -0.736" SUNAIR HEAVY 817 ALONE ALONE KH-1 175 WHERE EXPOSED SA-BD-2

RECESSED ROUND

SWITCHES

QUANTITY

85% SEE FILTER

ELECTRICAL

MODEL #

OPTION

RIGHT QUARTER END PANEL 26" TOP WIDTH, 0" BOTTOM WIDTH, 26" HIGH 430 SS.

RIGHT QUARTER END PANEL 26" TOP WIDTH, 0" BOTTOM WIDTH, 26" HIGH 430 SS.

KH-1 LEFT QUARTER END PANEL 26" TOP WIDTH, 0" BOTTOM WIDTH, 26" HIGH 430 SS.

JTILITY CABINET(S)

SIZE

4.0

4.0

2 KH-2 LEFT QUARTER END PANEL 26" TOP WIDTH, 0" BOTTOM WIDTH, 26" HIGH 430 SS.

													1					
2	KH-2	3650 SA-BD-2 SUNAIR	4′ 8″	600 DEG	I HEAV	Y 175	817	9″ 8	<i>"</i> 4 <i>"</i>		817 1634	-0.736″	430 SS WHERE EXPOSED	ALONE ALONE				
<u> 4001</u>	) INF	ORMATION																
			FILTER	(2			LIC	GHT(S)					UTIL	LITY CABINET(S)				1
HOOD	TAG				EFFICIENCY @	7			WIR	F				SYSTEM	ELECTRICAL	SWITCHES	FIRE SYSTEM	HL 1HAN
Ν□		TYPE	QTY HEIGHT	LENGTH  	MICRONS	QTY	Τ\	YPE	GÜAF		CATION	SIZE	TYPE	SIZE	MODEL #	QUANTITY	PIPING	WE:
1	KH-1	CAPTRATE SOLO FILTER	3 16"	16"	85% SEE FIL1 SPEC	ER 3	RECESSE	ED ROUND	NO								YES	2 L
			+ + +	<del>                                     </del>											+			+-

WEIGHT

200.00 LBS

200.00 LBS

EFFICIENCY VS. PARTICLE DIAMETER  $H\Box\Box$ D HANGING WEIGHT 203 LBS 203 LBS

PRESSURE DROP VS. FLOW RATE FLOW RATE (CFM)

PARTICLE DIAMETER (UM)

SPECIFICATION: CAPTRATE GREASE-STOP SOLO FILTER

TO DELIVER EXCEPTIONAL FILTRATION EFFICIENCY.

2-INCH DEEP HOOD CHANNEL(S).

COMPONENTS WHEN ASSEMBLED.

THE CAPTRATE GREASE-STOP SOLO FILTER IS A SINGLE-STAGE FILTER FEATURING

FILTER IS STAINLESS STEEL CONSTRUCTION, AND SIZED TO FIT INTO STANDARD

A UNIQUE S-BAFFLE DESIGN IN CONJUNCTION WITH A SLOTTED REAR BAFFLE DESIGN,

GREASE EXTRACTION EFFICIENCY PERFORMANCE SHALL REMOVE AT LEAST 75% OF GREASE

MANUFACTURER APPROVED FOR USE IN SOLID FUEL APPLICATIONS AS A SPARK ARRESTER.

THE CAPTRATE GREASE-STOP SOLO WAS TESTED TO ASTM STANDARD ASTM F2519-05.

PARTICLES FIVE MICRONS IN SIZE, AND 85% GREASE PARTICLES SEVEN MICRONS IN SIZE AND

LARGER, WITH A CORRESPONDING PRESSURE DROP NOT TO EXCEED 1.0 INCHES OF WATER GAUGE.

UNITS SHALL INCLUDE STAINLESS STEEL HANDLES AND A FASTENING DEVICE TO SECURE THE TWO

CAPTRATE FILTERS ARE BUILT IN COMPLIANCE WITH:


NFPA #96. NSF STANDARD #2. UL STANDARD #1046. INT. MECH. CODE (IMC). ULC-S649.

## WALL-MOUNT UTILITY CABINET ASSEMBLY INSTRUCTIONS


YES


CABINET TO BE HUNG BY OTHERS. SEE UTILITY CABINET SCHEDULE FOR CABINET SIZE.

HANGING ANGLE MUST BE SUPPORTED WITH 1/2" - 13 TPI GRADE 5 (MINIMUM) ALL-THREAD. SANDWICH HANGING ANGLES AND CEILING ANCHOR POINTS WITH 1/2" GRADE 5 (MINIMUM) STEEL FLAT WASHERS AND 1/2" - 13 TPI GRADE 5 (MINIMUM) HEX NUTS AS SHOWN. MUST USE DOUBLED HEX NUT CONFIGURATION BENEATH UTILITY CABINET HANGING ANGLES AND ABOVE CEILING ANCHORS. MAINTAIN 1/4" OF EXPOSED THREADS BENEATH BOTTOM

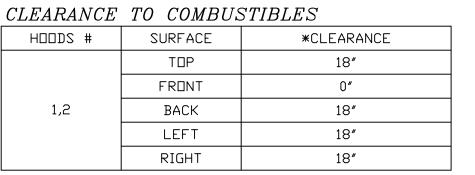

- \*0" CLEARANCE TO COMBUSTIBLES CONFORMS TO UL710 STANDARD.

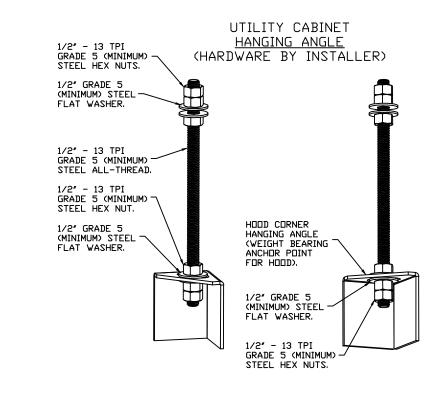


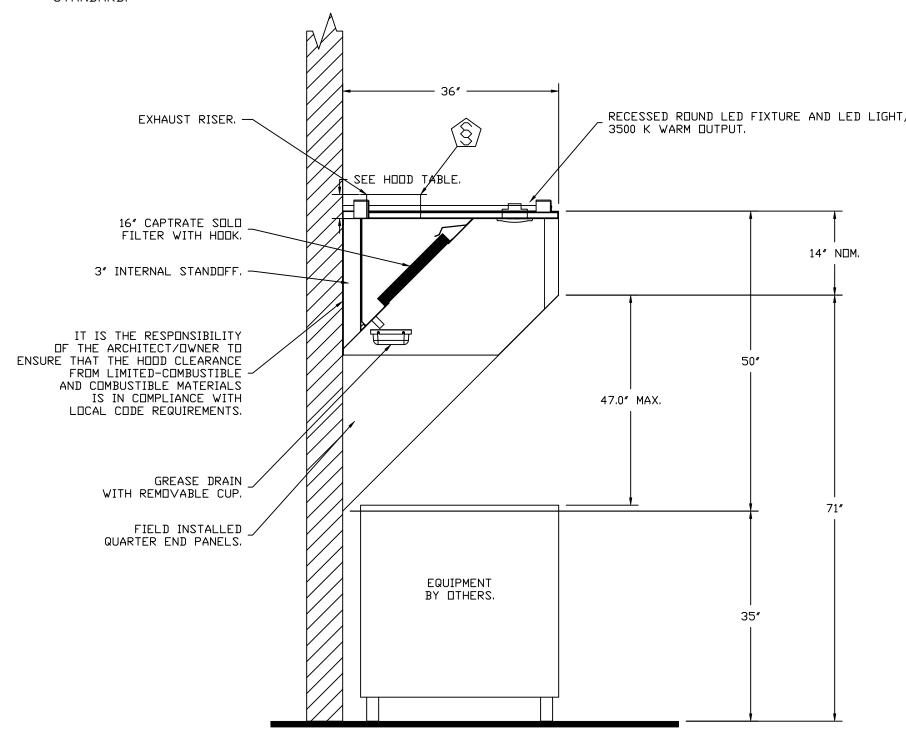

# U.L. LISTED RECESSED ROUND LED


PLAN VIEW - HOOD #1 (KH-1), #2 (KH-2) 4' 8.00" LONG 3650SA-BD-2

------ 4′ 8″N□M./4′ 8.00″□D. ------

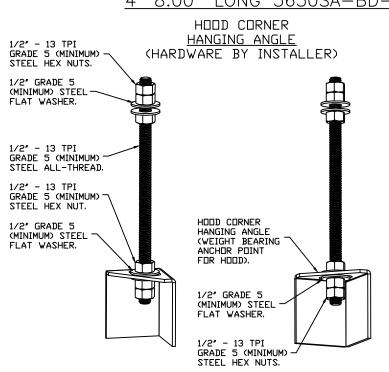

ASSEMBLY INSTRUCTIONS

HANGING ANGLE MUST BE SUPPORTED WITH 1/2" - 13 TPI GRADE 5 (MINIMUM) ALL-THREAD. SANDWICH HANGING ANGLES AND CEILING ANCHOR POINTS WITH 1/2" GRADE 5 (MINIMUM) STEEL FLAT WASHERS AND 1/2" - 13 TPI GRADE 5 (MINIMUM) HEX NUTS AS SHOWN, MUST USE DOUBLED HEX NUT CONFIGURATION BENEATH HOOD HANGING ANGLES AND ABOVE CEILING ANCHORS. MAINTAIN 1/4" OF EXPOSED THREADS BENEATH BOTTOM HEX NUT. TORQUE ALL HEX NUTS TO 57 FT-LBS.

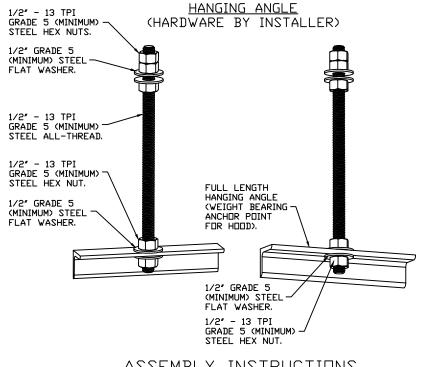

FULL LENGTH

ASSEMBLY INSTRUCTIONS

HANGING ANGLE MUST BE SUPPORTED WITH 1/2" - 13 TPI HEX NUT. TORQUE ALL HEX NUTS TO 57 FT-LBS. GRADE 5 (MINIMUM) ALL-THREAD, SANDWICH HANGING ANGLES AND CEILING ANCHOR POINTS WITH 1/2" GRADE 5 (MINIMUM) STEEL FLAT WASHERS AND 1/2" - 13 TPI GRADE 5 (MINIMUM) HEX NUTS AS SHOWN, MUST USE DOUBLED HEX NUT CONFIGURATION ABOVE CEILING ANCHORS, SINGLE HEX NUT BENEATH HANGING ANGLE IS ACCEPTABLE FOR FULL LENGTH HANGING ANGLES. MAINTAIN 1/4" OF EXPOSED THREADS BENEATH BOTTOM HEX NUT. TORQUE ALL HEX NUTS TO 57 FT-LBS.

<u>SECTION VIEW - MODEL 3650SA-BD-2</u> HOOD - #1 (KH-1), #2 (KH-2)

**REVISIONS** DESCRIPTION DATE

 $\mathbb{T}$ Spic Z  $\bigcirc$  $\bigcirc$  $\bigcirc$  $\Box$ 

 $\cong$ 

**DATE:** 11/20/2024 DWG.#: 7179537

**DRAWN BY:** Ryan Fung

SCALE: 3/4" = 1'-0"

**MASTER DRAWING** 

<u>FIRE</u>	SYST	EM INFORMATIO	ON - JOB#7179537		
FIRE	- - - - N - TAC	TVDE		MAY ED	DES:

<u> </u>	$\nu$	JIM TIVI OIVIMATIC	<u> </u>				
FIRE			,		DESIGN	INSTALLATIO	N
SYSTEM NO	TAG	TYPE	SIZE	MAX FP	FP	SYSTEM	LOCATION ON HOOD
1		TANK FS	4.0	20	18	WALL UTILITY CABINET RIGHT	N/A
2		TANK FS	4.0	20	18	WALL UTILITY CABINET LEFT	N/A

GAS VALVE(S)

GAS VAI	VEID	J		
FIRE SYSTEM NO	TAG	TYPE	SIZE	SUPPLIED BY
1		SC ELECTRICAL	2.000	CAPTIVEAIRE SYSTEMS
2		SC ELECTRICAL	2.000	CAPTIVEAIRE SYSTEMS

	YSTEI	M PARTS LIST KEY	1	
FIRE SYSTEM NO	TAG	KEY NUMBER - PART DESCRIPTION	QTY BY FACTORY	QTY BY DIST
		0 - 0 - 12-F28021-32144-DT-360 DUCT FIRE THERMOSTAT WITH 12 FOOT WIRE LEADS. NO, CLOSE ON TEMP RISE AT 360°F. (A0034310).	1	0
		0 - 0 - 87-300001-001 TANK - PRESSURIZED TANK USED FOR TANK FIRE SUPPRESSION.	1	0
		0 - 0 - 87-300030-001 PRIMARY ACTUATOR KIT (PAK) - ACTUATOR AND RELEASE SOLENOID ASSEMBLY, ONE NEEDED PER FIRE SYSTEM, SUPERVISED, TANK FIRE SUPPRESSION.	1	0
		0 - 0 - 87-300152-001 HARDWARE, SVA BOLTS, TANK FIRE SUPPRESSION.	4	0
		0 - 0 - 98694A115 HARDWARE, DATANKLOCK LOCKING BRACKET SQUARE NUTS 5/16" ZINC, TANK FIRE SUPPRESSION.	2	0
		0 - 0 - A0034332 JUNCTION BOX FOR MANUAL PULL STATION, 1.5" DEEP BACK BOX, RED COLOR.	1	0
1		0 - 0 - DATANKLOCK DISCHARGE ADAPTER TANK LOCKING PLATE FOR FIRE SYSTEM TANK INSTALLATION IN UTILITY CABINETS, TANK FIRE SUPPRESSION.	1	0
		0 - 0 - SLPCON-10FT SUPERVISED LOOP CONNECTION KIT. CONTAINS THE PARTS NEEDED TO CONNECT THE SUPERVISED LOOP BETWEEN END TO END HOODS WITH LESS THAN A 9' GAP OR BACK TO BACK HOODS. KIT CONTAINS 12 FEET OF BLACK MG WIRE, 12 FEET OF TAN MG WIRE, 10 FEET OF FLEXIBLE CONDUIT, AND TWO 7/8" CONNECTORS.	2	0
		0 - 0 - TANK STRAP TANK STRAP - USED FOR TANK FIRE SUPPRESSION.	3	0
		0 - 0 - TFS-UCTANKBRACKET TANK BRACKET FOR FIRE SYSTEM TANK INSTALLATION IN UTILITY CABINETS, TANK FIRE SUPPRESSION.	1	0
		0 - 0 - WK-283952-000 DISCHARGE ADAPTER, TANK FIRE SUPPRESSION.	1	0
		34 - 34 - A0034331 24VDC SINGLE ACTION MANUAL ACTUATION DEVICE (PUSH/PULL STATION) WITH PROTECTIVE COVER, ONE (1) NORMALLY OPEN CONTACT, RED COLOR.	1	0
		0 - 0 - TANK FIRE SUPPRESSION MAINTENANCE GUIDE UTILITY CABINET LABEL SHEET.	1	0
		0 - 0 - TANK FIRE SUPPRESSION POST-DISCHARGE PROCEDURE UTILITY CABINET LABEL SHEET.	1	0
		0 - 0 - 12-F28021-32144-DT-360 DUCT FIRE THERMOSTAT WITH 12 FOOT WIRE LEADS, NO, CLOSE ON TEMP RISE AT 360°F. (A0034310).	1	0
		0 - 0 - 4429K153 1/2" MALE NPT TO 1/2" FEMALE NPT ELBOW, BRASS.	1	0
		0 - 0 - 4429K422 1/2" X 1/4" BRASS REDUCING BUSHING.	1	0
		0 - 0 - 79525 1/2" 90 PRO-PRESS ELBOW WITH 1/2" NPT FEMALE CONNECTION, VIEGA.	1	0
		0 - 0 - 79580 1/2" X 1/2" PRO-PRESS TEE X 1/2" NPT FEMALE CONNECTION, VIEGA.	1	0
		0 - 0 - 87-300001-001 TANK - PRESSURIZED TANK USED FOR TANK FIRE SUPPRESSION.	1	0
		0 - 0 - 87-300030-001 PRIMARY ACTUATOR KIT (PAK) - ACTUATOR AND RELEASE SOLENDID ASSEMBLY, ONE NEEDED PER FIRE SYSTEM, SUPERVISED, TANK FIRE SUPPRESSION.	1	0
		0 - 0 - 87-300152-001 HARDWARE, SVA BOLTS, TANK FIRE SUPPRESSION.	4	0
2		0 - 0 - 98694A115 HARDWARE, DATANKLOCK LOCKING BRACKET SQUARE NUTS 5/16" ZINC, TANK FIRE SUPPRESSION.	2	0
_		0 - 0 - A0034332 JUNCTION BOX FOR MANUAL PULL STATION. 1.5" DEEP BACK BOX, RED COLOR.	1	0
		0 - 0 - A31484 1/4" NPT SCHRADER VALVE AND CAP, JB INDUSTRIES. 1/4" FLARE X 1/4" MPT HALF UNION. USED ON TANK SERVICE PORT.	1	0
		0 - 0 - DATANKLOCK DISCHARGE ADAPTER TANK LOCKING PLATE FOR FIRE SYSTEM TANK INSTALLATION IN UTILITY CABINETS, TANK FIRE SUPPRESSION.	1	0
		0 - 0 - SLPCON-10FT SUPERVISED LOOP CONNECTION KIT. CONTAINS THE PARTS NEEDED TO CONNECT THE SUPERVISED LOOP BETWEEN END TO END HOODS WITH LESS THAN A 9' GAP OR BACK TO BACK HOODS. KIT CONTAINS 12 FEET OF BLACK MG WIRE, 12 FEET OF TAN MG WIRE, 10 FEET OF FLEXIBLE CONDUIT, AND TWO 7/8" CONNECTORS.	2	0
		0 - 0 - TANK STRAP TANK STRAP - USED FOR TANK FIRE SUPPRESSION.	3	0
		0 - 0 - TFS-UCTANKBRACKET TANK BRACKET FOR FIRE SYSTEM TANK INSTALLATION IN UTILITY CABINETS, TANK FIRE SUPPRESSION.	1	0
		0 - 0 - WK-283952-000 DISCHARGE ADAPTER, TANK FIRE SUPPRESSION.	1	0
		34 - 34 - A0034331 24VDC SINGLE ACTION MANUAL ACTUATION DEVICE (PUSH/PULL STATION) WITH PROTECTIVE COVER, ONE (1) NORMALLY OPEN CONTACT, RED COLOR.	1	0
		ADDITIONAL PARTS TO BE DETERMINED		

**REVISIONS** 

25 Brightwood Str Toronto, ON, M3H Hospice Neshama

**DATE:** 11/20/2024 **DWG.#:** 7179537

**DRAWN BY:** Ryan Fung

**SCALE:** 3/4" = 1'-0"

MASTER DRAWING

EXH.	AUST	FAN	INFORMATION - JOB#71	79537												
FAN UNIT NO	TAG	QTY	FAN UNIT MODEL #	MANUFACTURER	CFM	ESP	RPM	MOTOR ENCL	HP	BHP	PHASE	VOLT	FLA	DISCHARGE VELOCITY	WEIGHT (LBS)	SONES
1	KEF-1	1	SA-USBI11DD-RM	SUNAIR	817	2.500	2334	ODP,PREMIUM	2.000	0.7700	3	208	5.4	871 FPM	284	21.1
2	KEF-2	1	SA-USBI11DD-RM	SUNAIR	817	2.500	2334	ODP,PREMIUM	2.000	0.7700	3	208	5.4	871 FPM	284	21.1

<u>FAN</u>	<u>OPTION</u>	<i>IS</i>	
FAN UNIT NO	TAG	QTY	DESCRIPTION
		1	UTILITY SET GREASE CUP
		1	BI - DISCHARGE ORIENTATION VERTICAL UPPER LEFT - CW INLET SIDE
		1	CURB MOUNTED SLED FOR USBI 11. USED TO MOUNT ON 41" L X 27" W CURB
1	KEF-1	1	BI11 - RAIN CAP ASSEMBLY
		1	BI11 - INLET RING USED TO CONNECT NON-FACTORY DUCT
		1	BLUE RUBBER VIBRATION ISOLATORS FOR BI UTILITY SETS (SET OF 4)
		1	2 YEAR PARTS WARRANTY
		1	UTILITY SET GREASE CUP
		1	BI - DISCHARGE ORIENTATION VERTICAL UPPER LEFT - CW INLET SIDE
		1	CURB MOUNTED SLED FOR USBI 11. USED TO MOUNT ON 41" L X 27" W CURB
2	KEF-2	1	BI11 - RAIN CAP ASSEMBLY
		1	BI11 - INLET RING USED TO CONNECT NON-FACTORY DUCT
		1	BLUE RUBBER VIBRATION ISOLATORS FOR BI UTILITY SETS (SET OF 4)

# FAN ACCESSORIES

FAN UNIT	TAG		EXHAUST	SUPPLY					
ND	TAG	GREASE CUP	GRAVITY DAMPER	SIDE DISCHARGE	GRAVITY DAMPER	MOTORIZED DAMPER	WALL MOUNT		
1	KEF-1	YES							
N	KEF-2	YES							

1 2 YEAR PARTS WARRANTY

### CURB ASSEMBLIES


ND	□N FAN	TAG	WEIGHT	ITEM	SIZE
1	# 1	KEF-1	39 LBS	CURB	27.000"W X 41.000"L X 12.000"H.
2	# 2	KEF-2	39 LBS	CURB	27.000"W X 41.000"L X 12.000"H.


# FAN SOUND DATA


FAN UNIT TAG MOTOR SOUND DATA  SOUND DATA  LWA SONES		OCTAVE BAND SOUND DATA												
	TAU	MUTUR	LWA	SONES @ 5 FT	DBA @ 5 FT	DISTANCE (FT)	63 HZ	125 HZ	250 HZ	500 HZ	1 KHZ	2 KHZ	4 KHZ	8 KHZ
1	KEF-1	EXHAUST	83,5	21.1495535800634	72	5	75.2	85.5	86	82	77.4	72.5	66.7	60.7
2	KEF-2	EXHAUST	83.5	21.1495535800634	72	5	75.2	85.5	86	82	77.4	72.5	66.7	60.7


# FANS #1 (KEF-1) #2 (KEF-2) - EXHAUST PERFORMANCE CURVES.


# 817 CFM, 2.5 SP @ 2334 RPM AND 0.77 BHP AT 492 FEET AND 120 DEG F.

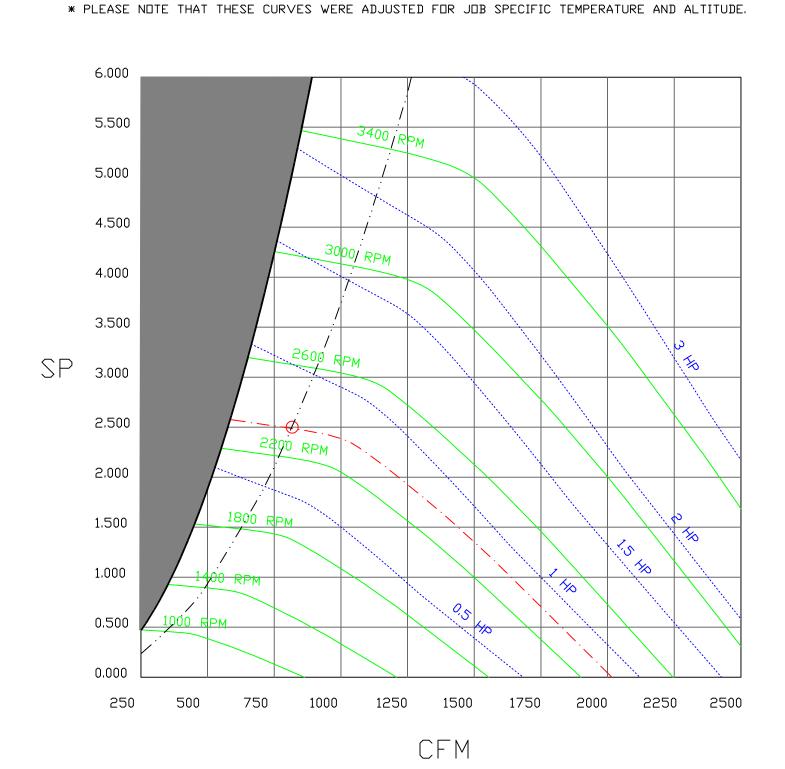


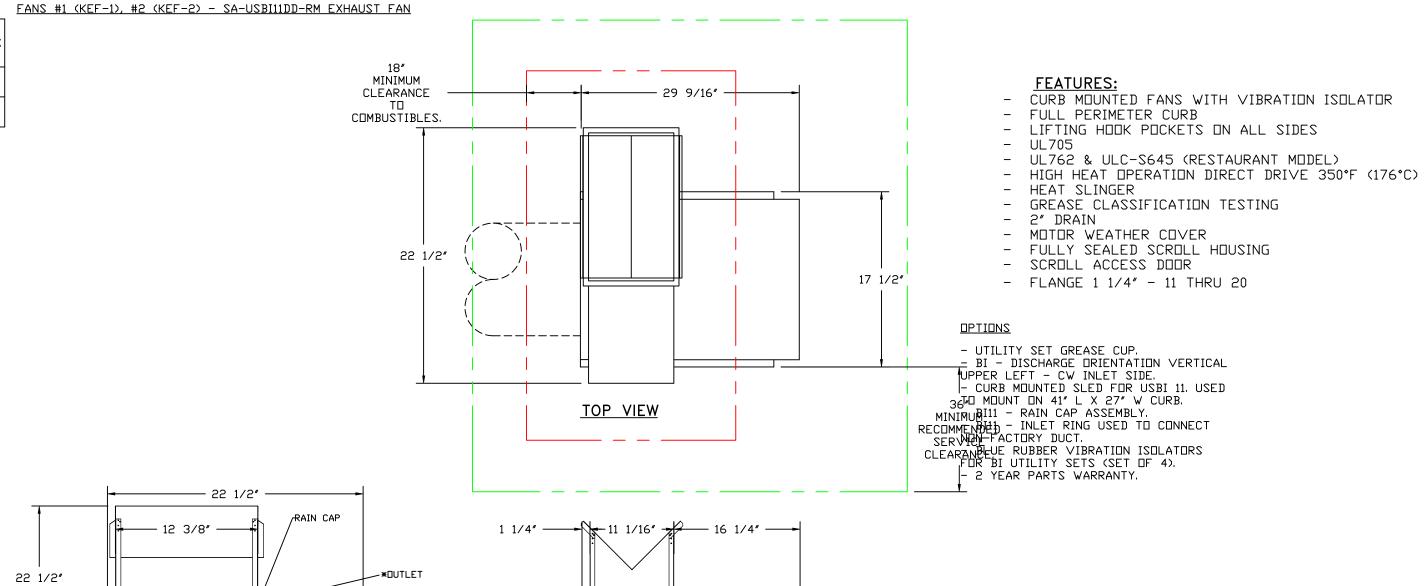

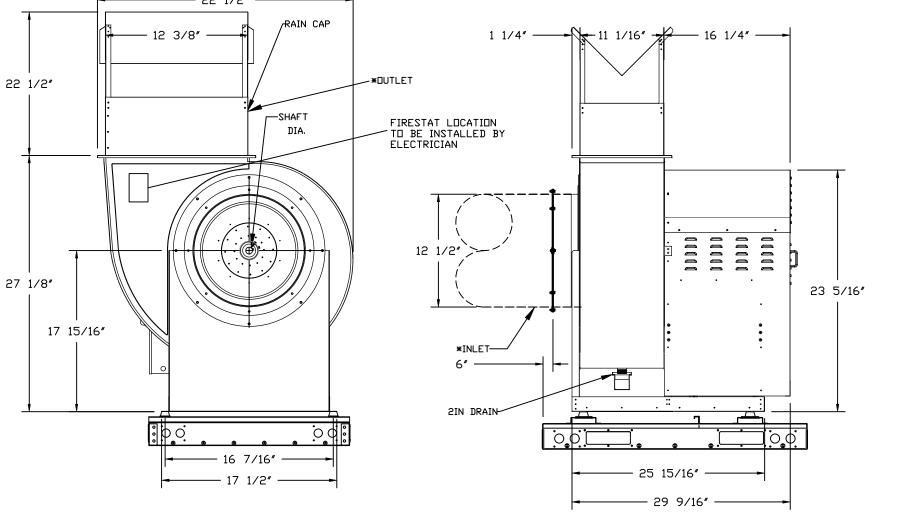

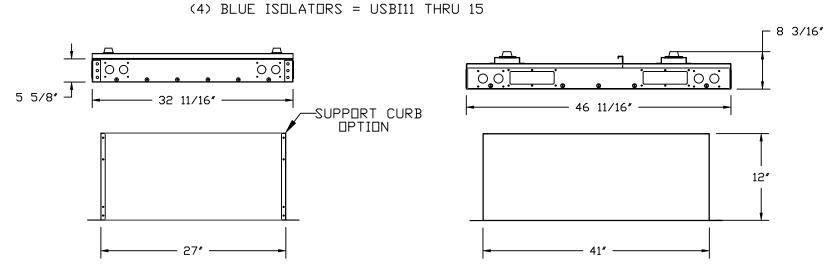

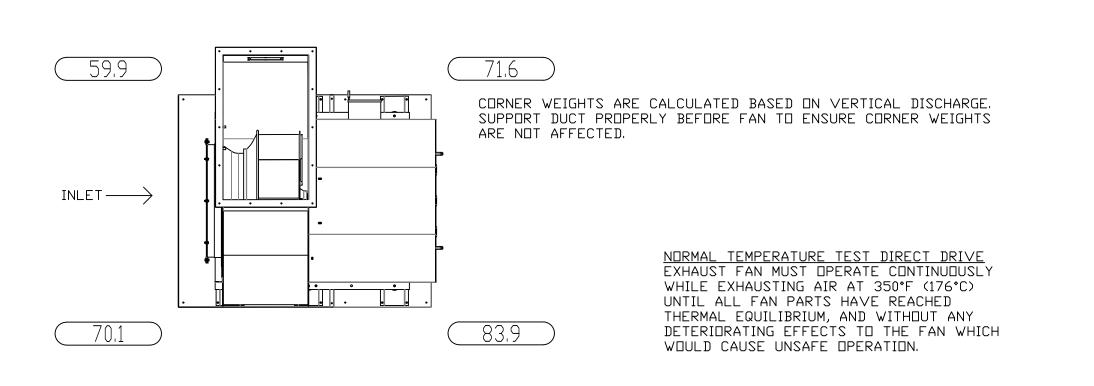

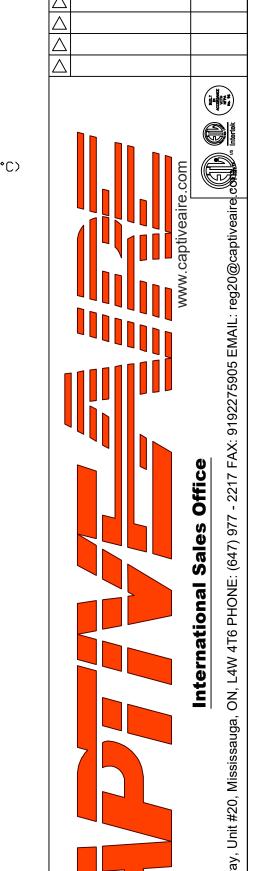

**REVISIONS** 

+ $\cong$ <u>-</u>  $\bigcirc$  $\sim$ **DATE:** 11/20/2024

DWG.#: 7179537

**DRAWN BY:** Ryan Fung

SCALE: 3/4" = 1'-0"

**MASTER DRAWING** 

	Exhaust Fan Wiring	J□B	7179537 - Ne	shama H	ospice R
	DRAWING NUMBER EXH7179537-2	SHIP DATE	11/20/2024	MODEL	SA-USB
<u>Installed Options</u>					
Component Identification Lakel Description Location	3 OBK				BK BK BK
MT-01 Fan Motor [3] SW-01 Main disconnect switch [3]	4 oGR				
	<ul><li>7</li><li>8</li><li>9</li></ul>				
	10 11 12				
	<ul><li>13</li><li>14</li><li>15</li></ul>				
MOTOR INFO EXHAUST 2.0HP-208V-3P-5.4FLA VFD PART: ESV152N02YXB571  ELECTRICAL INFORMATION	16 17 18				
FLECTRICAL INFORMATION MOTOR/CTRL MCA: 6.8A MOTOR/CTRL MOP: 15A	19 20				
DENDTES FIELD WIRING  DENDTES INTERNAL WIRING  WIRE COLOR  BK - BLACK YW - YELLOW  BL - BLUE GR - GREEN  BR - BROWN GY - GRAY  OR - ORANGE PR - PURPLE  RD - RED PK - PINK	21				

7179537 - Neshama Hospice R3

SHIP DATE 11/20/2024 MODEL SA-USBI11DD-RM

Exhaust Fan Wiring DRAWING NUMBER EXH7179537-1

Exhaust Fan Wiring	JDB	7179537 - Ne			
DRAWING NUMBER EXH7179537-2	SHIP DATE	11/20/2024	MODEL	SA-USBI11DD-RM	
					<u>Installed Options</u>
BK 17 = 2-51					<u>Component Identification</u> Label Description Locatio
OBK 13				BK BK MT-01	
					SW-01 Main disconnect switch [3]
2					
5					MOTOR INFO EXHAUST 2.0HP-208V-3P-5.4FLA VFD PART: ESV152N02YXB571
3					ELECTRICAL INFORMATION
					ELECTRICAL INFORMATION MOTOR/CTRL MCA: 6.8A MOTOR/CTRL MOP: 15A
					NOTES DENOTES FIELD WIRING DENOTES INTERNAL WIRING
2					WIRE COLOR  BK - BLACK YW - YELLOW  BL - BLUE GR - GREEN  BR - BROWN GY - GRAY  OR - URANGE PR - PURPLE

25 Brightwood Str Toronto, ON, M3H

Hospice

Neshama

**DATE:** 11/20/2024

**DWG.#:** 7179537

**DRAWN BY:** Ryan Fung


**SCALE:** 3/4" = 1'-0"

MASTER DRAWING

SHEET NO.

REVISIONS

ELI	ECTRICAL	PACKAGE	- J0B#7179537									
   N□	TAG	   PACKAGE #	LOCATION	SWITCH	HES	OPTION	FANS	CONTROLL	ED			
				LOCATION	QUANTITY		FAN TAG	TYPE	ф	HP	VOLT	FLA
1		SC-310110MA	WALL MOUNT IN SS BOX	SS WALL MOUNT	1 LIGHT	SMART CONTROLS THERMOSTATIC CONTROL	KEF-1	EXHAUST	3	2.000	208	5.4
				ВПХ	1 FAN	W/ RELAY DN/DFF WITH SUPPLY				<u> </u>	<u> </u>	
2		SC-310110MA	WALL MOUNT IN SS BOX	SS WALL MOUNT	1 LIGHT	SMART CONTROLS THERMOSTATIC CONTROL W/ RFLAY ON/OFF WITH SUPPLY	KEF-2	EXHAUST	3	2.000	208	5.4

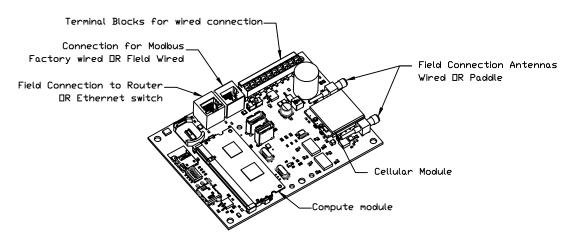

# <u>CASlink Monitor and Control</u>

- Hood control panel to support communications to cloud-based Building - Hood Control Panel to allow cloud-based Building Management System to monitor real time parameters outlined as MONITOR in the points list. - Hood Control Panel to allow cloud-based Building Management System to control parameters outlined as CONTROL in the points list.


- Hood Control Panel to allow cloud-based Building Management System to implement SYSTEM ECONOMIZER control strategies for fully integrated Building Management.

# MONITORING AND CONTROL POINTS LIST

DCV Packages	Function	SC Packages	Function
Room Temperature	MONITOR	Room Temperature(s)	MONITOR
Duct Temperature(s)	MONITOR	Duct Temperature(s)	MONITOR
MUA Discharge Temperature	MONITOR	MUA DIscharge Temperature	MONITOR
Kitchen RTU Discharge Temperature	MONITOR	Kitchen RTU Discharge Temperature	MONITOR
Fan Speed	MONITOR	Controller Faults	MONITOR
Fan Amperage	MONITOR	Fan Faults	MONITOR
Fan Power	MONITOR	Fan Status	MONITOR
VFD Faults	MONITOR	PCU Faults	MONITOR
Controller Faults	MONITOR	PCU Filter Clog Percentages	MONITOR
Fan Faults	MONITOR	Fire Condition	MONITOR
Fan Status	MONITOR	CORE Fire System	MONITOR
PCU Faults	MONITOR	Building Pressures	MONITOR
PCU Filter Clog Percentages	MONITOR	Fans Button(s)	MONITOR & CONTR
Fire Condition	MONITOR	Lights Button(s)	MONITOR & CONTR
CORE Fire System	MONITOR	Wash Button	MONITOR & CONTR
Building Pressures	MONITOR		
Prep Time Button	MONITOR & CONTROL		
Fans Button	MONITOR & CONTROL		
Lights Button	MONITOR & CONTROL		

MONITOR & CONTROL

Wash Button

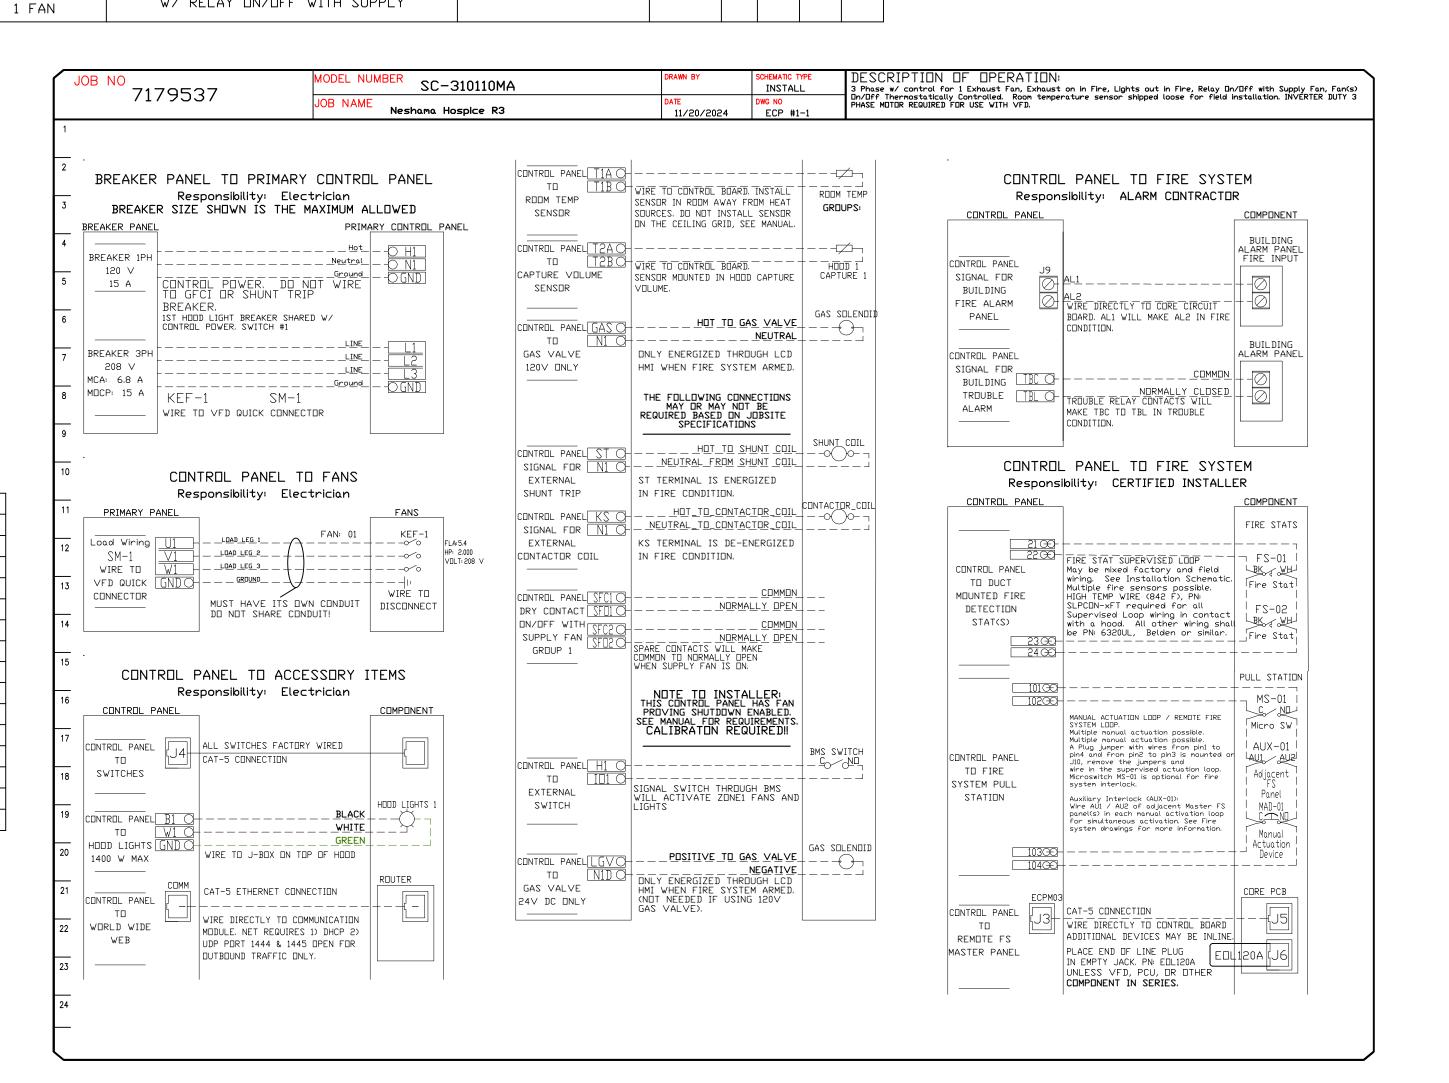

**REVISIONS** 


+ $\mathbb{A}_{\mathbb{A}}$ Spin  $\overline{\bigcirc}$ Z  $\circ$  $\cap$ 


**DATE:** 11/20/2024

7179537 **DRAWN BY:** Ryan Fung

SCALE: 3/4" = 1'-0"

**MASTER DRAWING** 

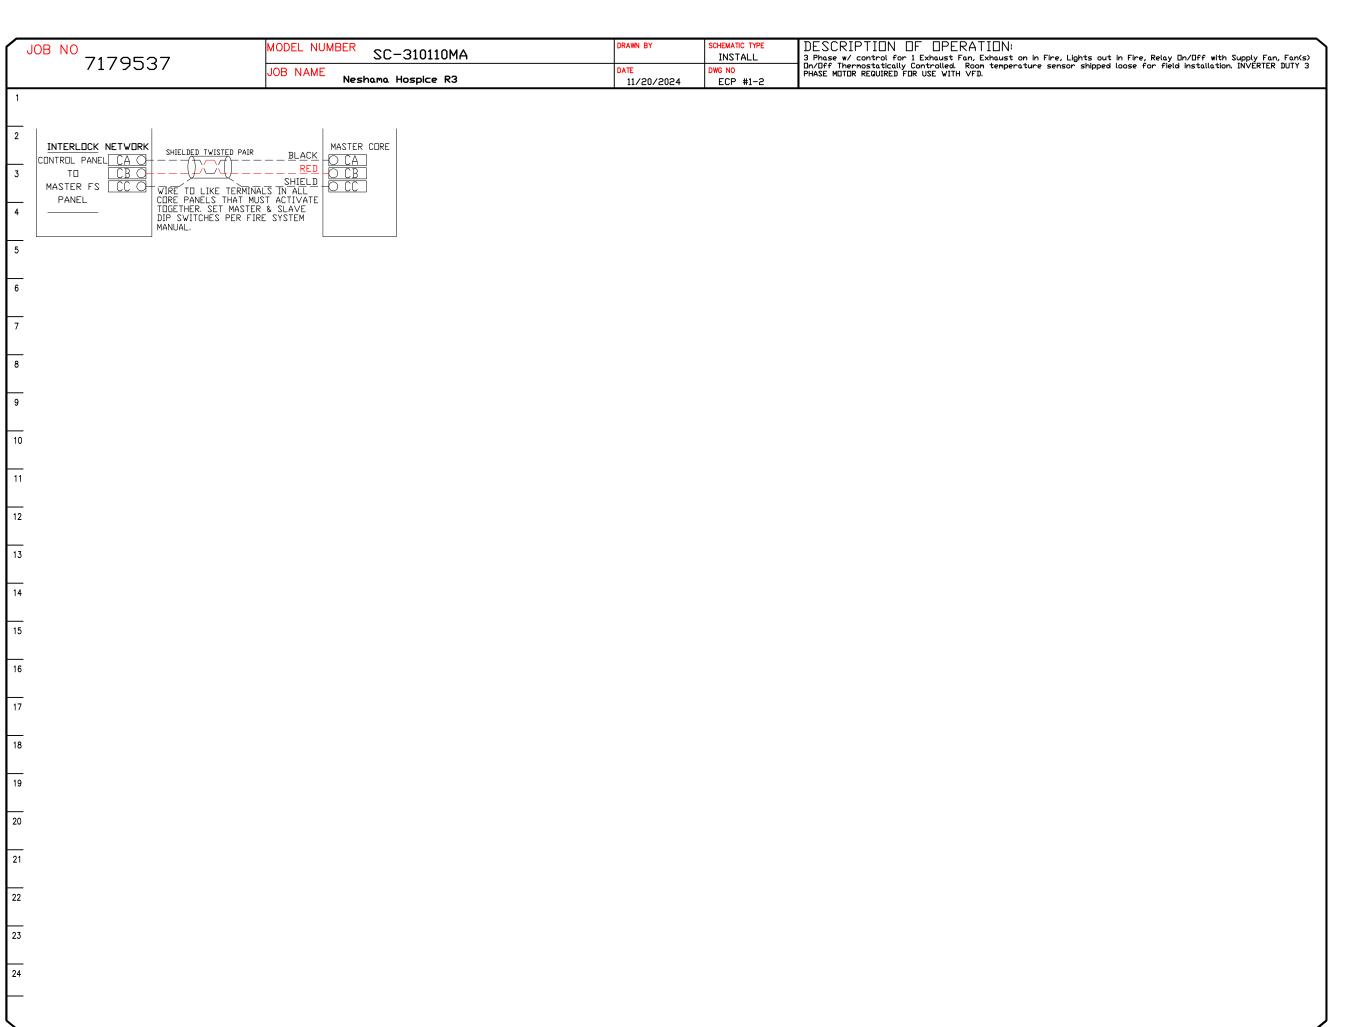

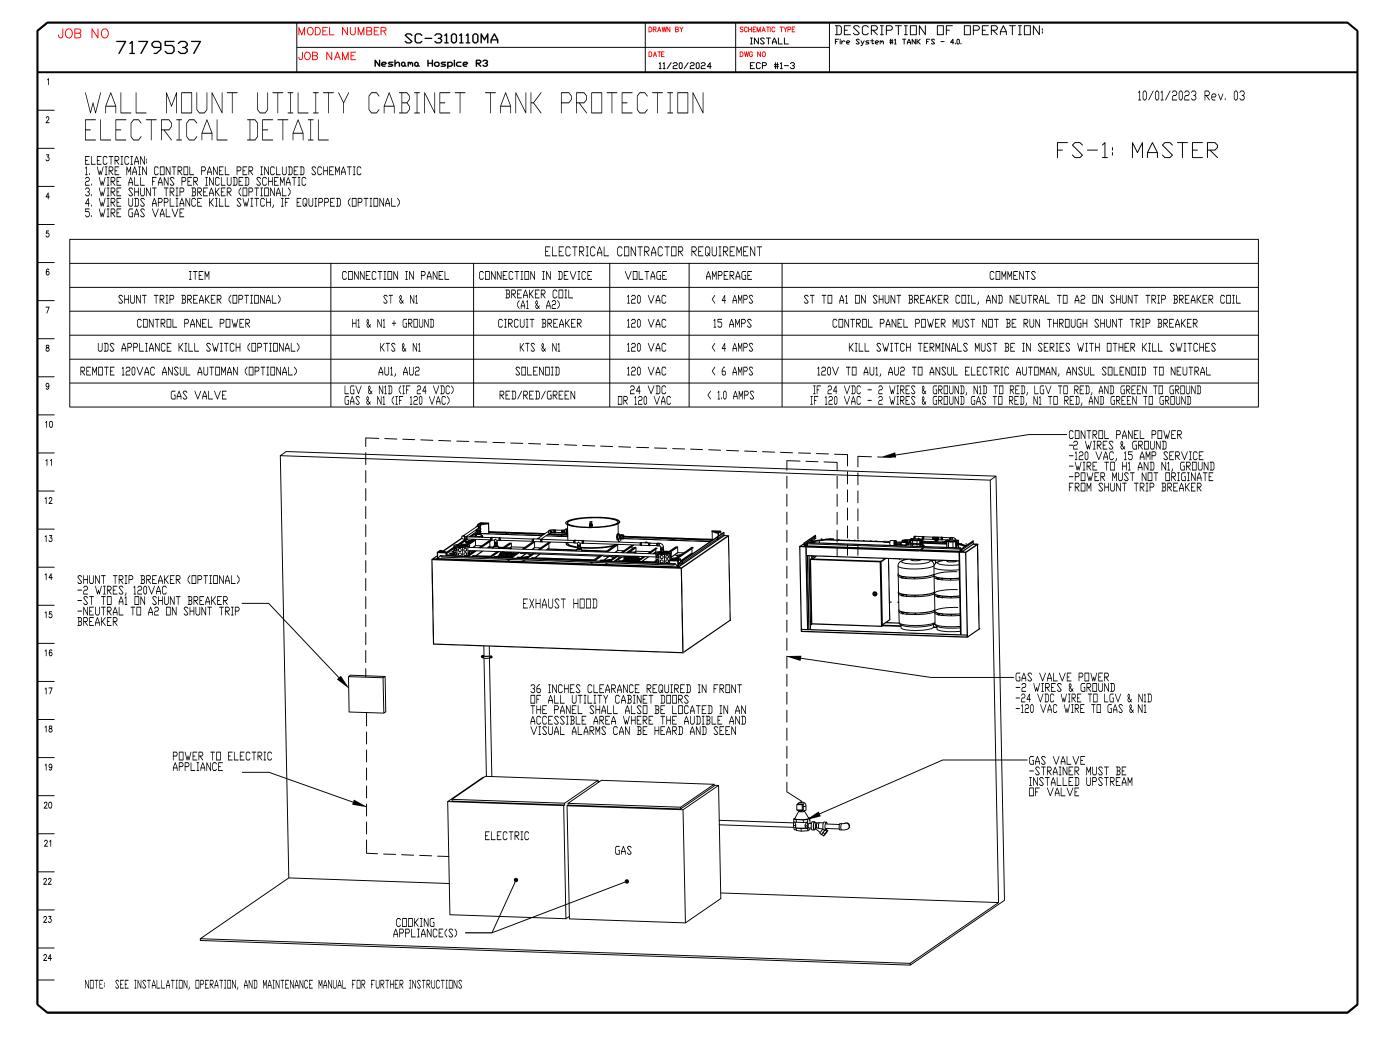



**REVISIONS** 

Neshama Hospice R3

25 Brightwood Street,
Toronto, DN, M3H 227


DATE: 11/20/2024


DWG.#:
7179537

DRAWN BY: Ryan Fung

**SCALE:** 3/4" = 1'-0"

MASTER DRAWING

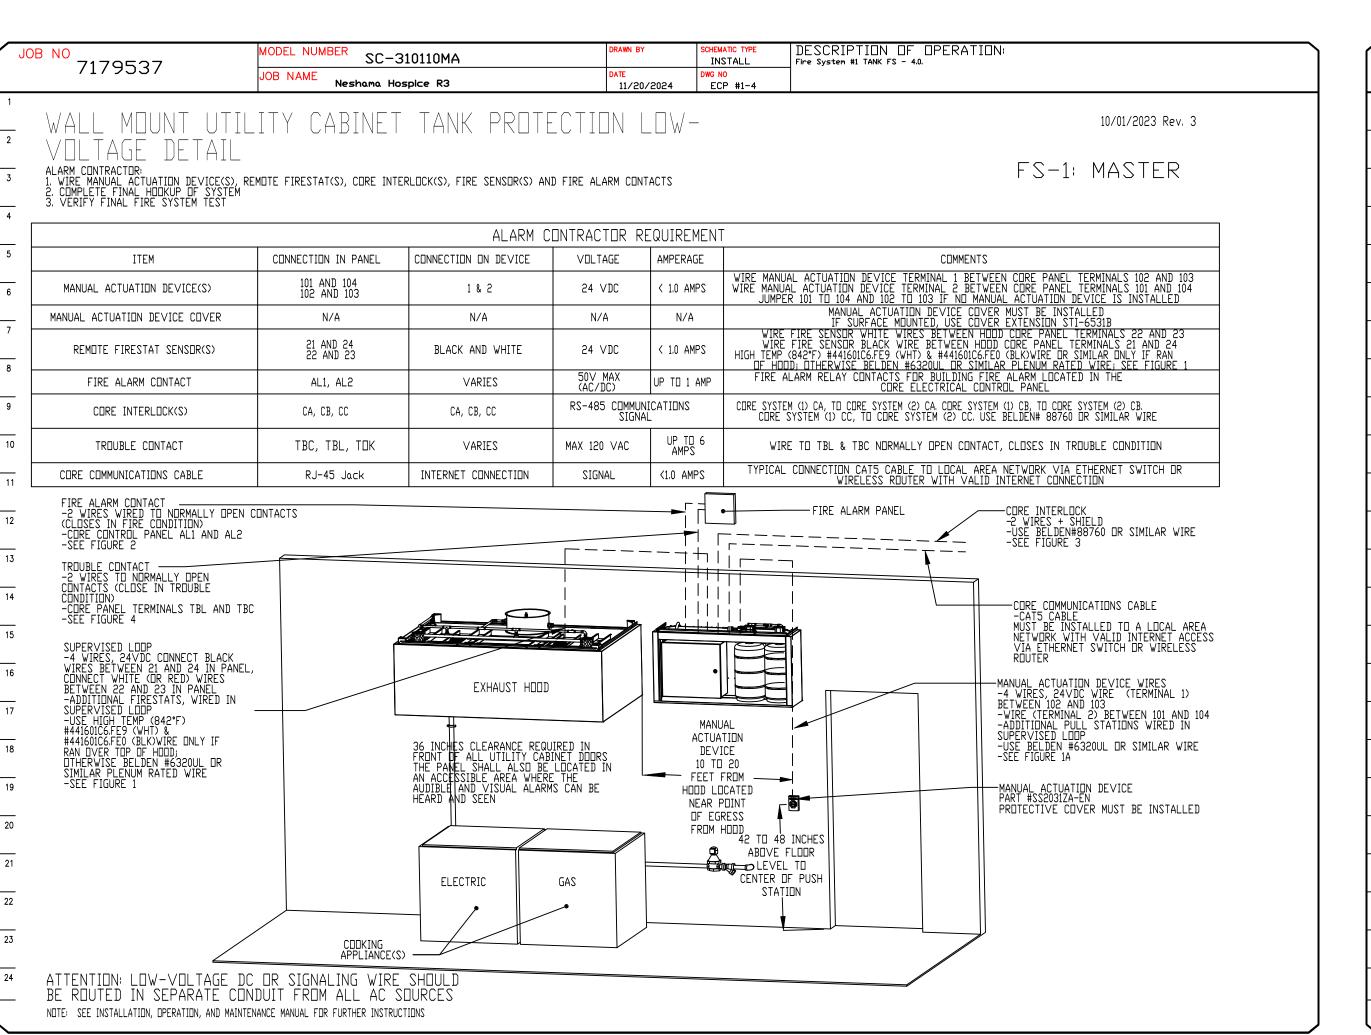

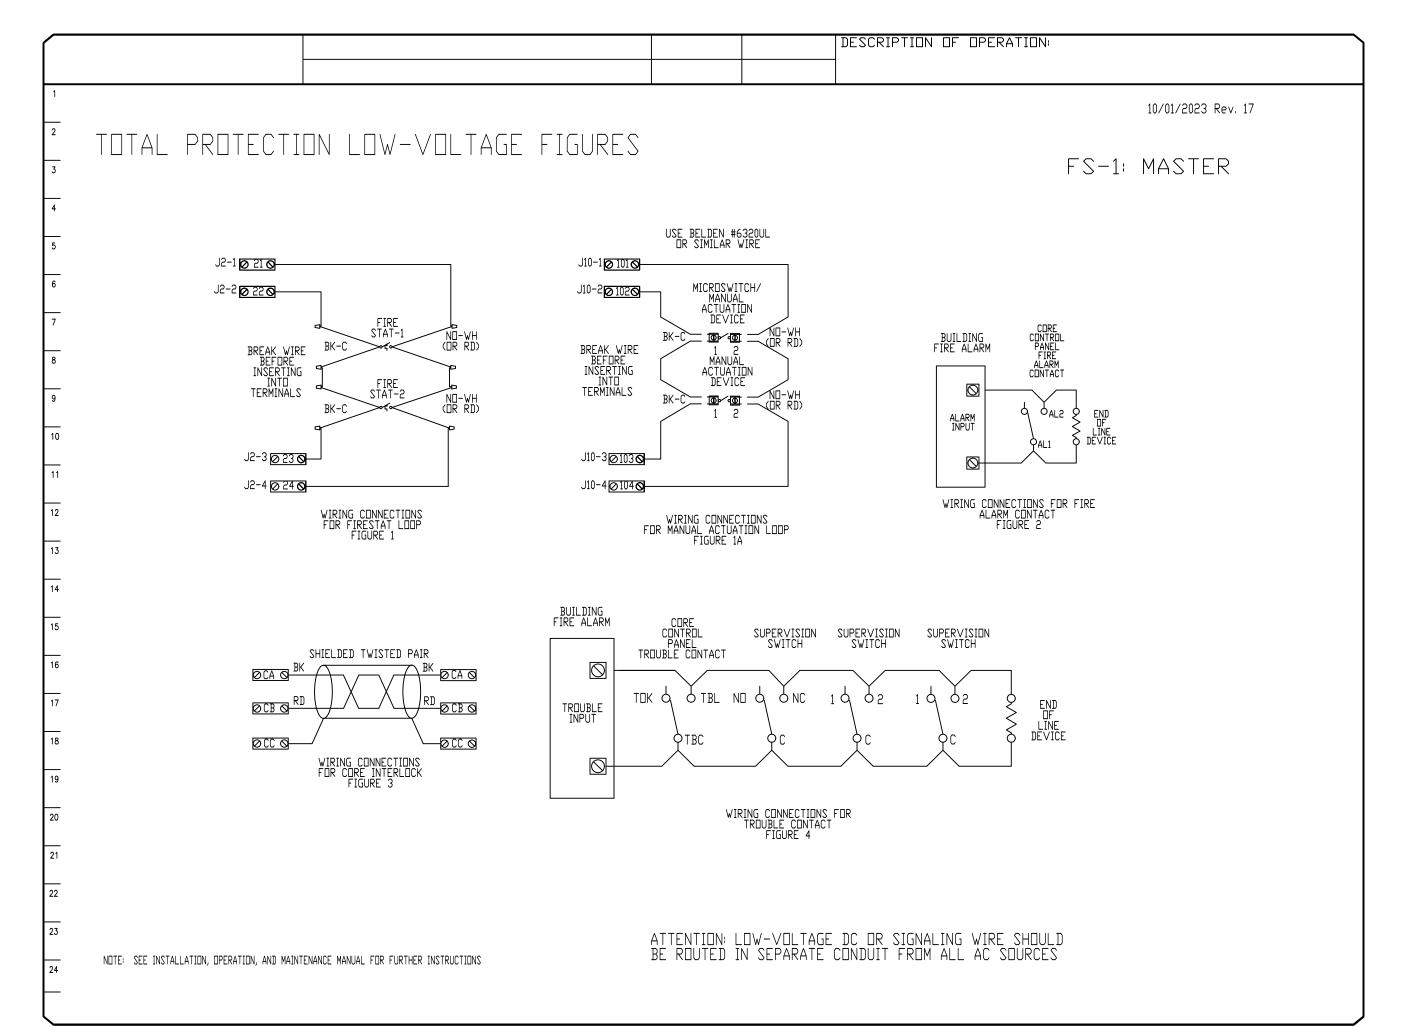



**REVISIONS** 


 $\mathbb{A} \mathbb{A}$ Hospice W00W Z Brigh. 0 


**DATE:** 11/20/2024 DWG.#:


7179537 **DRAWN BY:** Ryan Fung

**SCALE:** 3/4" = 1'-0"

**MASTER DRAWING** 

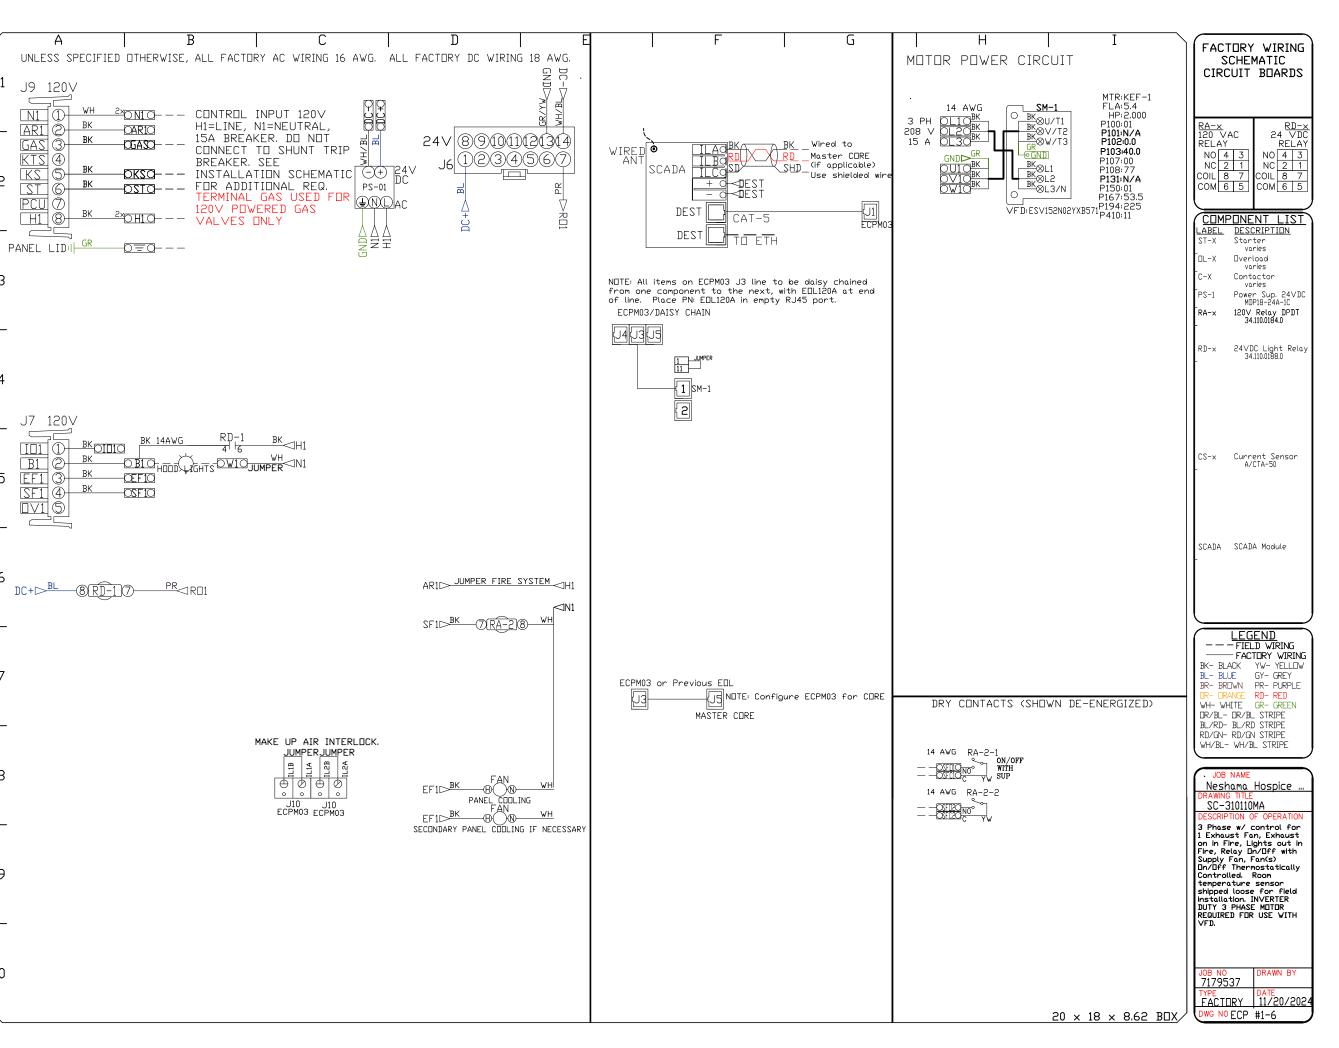

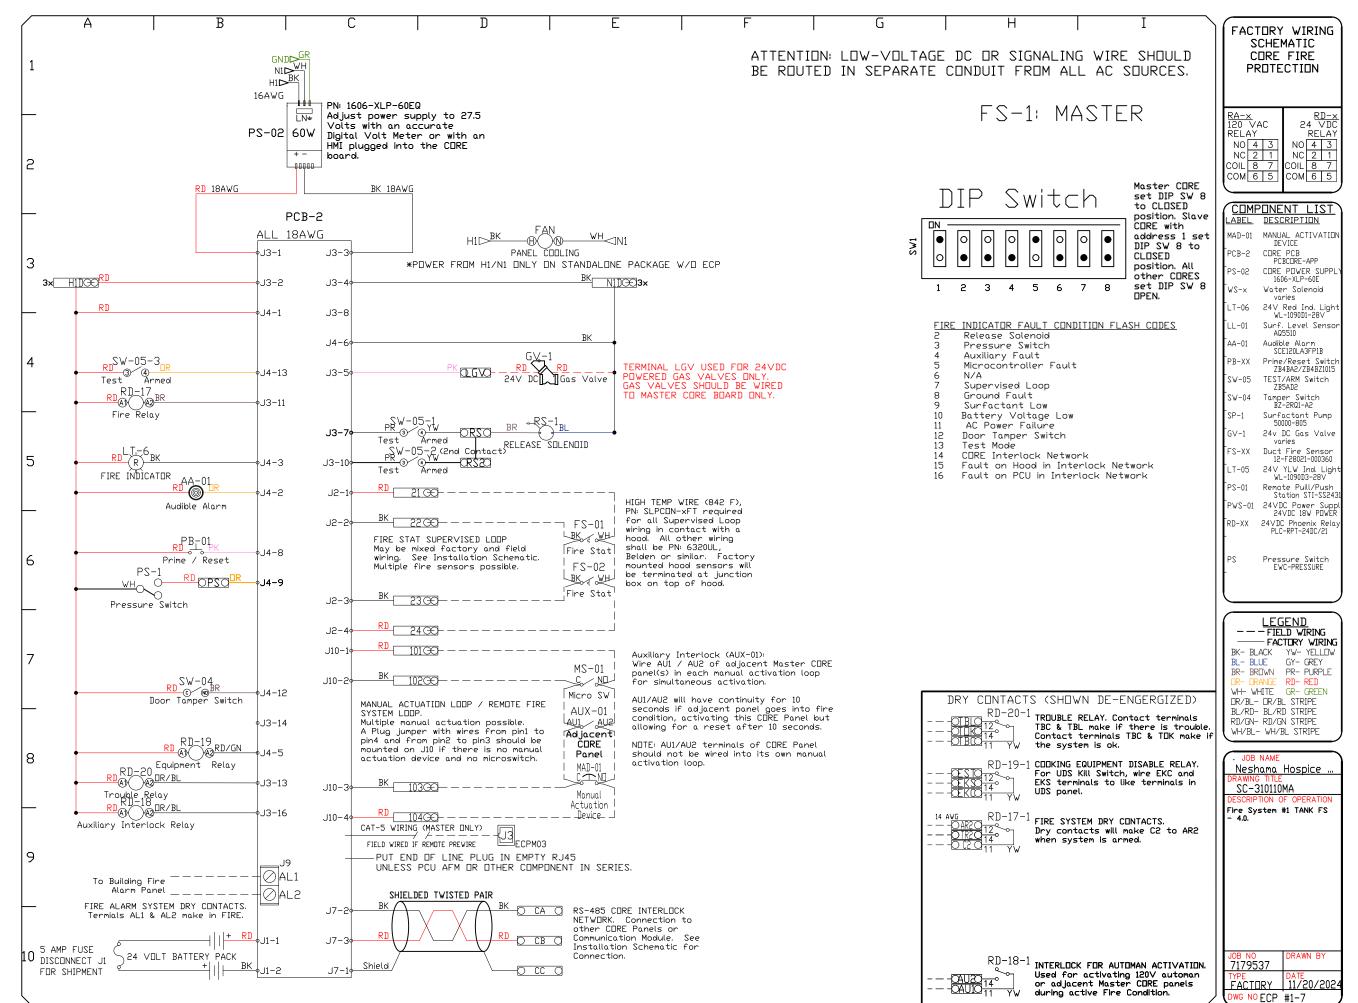

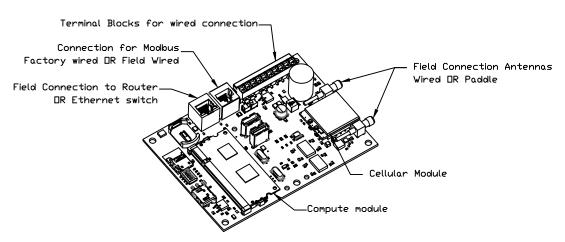


# CASlink Monitor and Control

- Hood control panel to support communications to cloud-based Building Management System.
   Hood Control Panel to allow cloud-based Building Management System to monitor real time parameters outlined as MONITOR in the points list.
- Hood Control Panel to allow cloud-based Building Management System to control parameters outlined as CONTROL in the points list.
   Hood Control Panel to allow cloud-based Building Management System to implement SYSTEM ECONOMIZER control strategies for fully integrated Building

# MONITORING AND CONTROL POINTS LIST

DCV Packages	Function	SC Packages	Function
Room Temperature	MONITOR	Room Temperature(s)	MONITOR
Duct Temperature(s)	MONITOR	Duct Temperature(s)	MONITOR
MUA Discharge Temperature	MONITOR	MUA DIscharge Temperature	MONITOR
Kitchen RTU Discharge Temperature	MONITOR	Kitchen RTU Discharge Temperature	MONITOR
Fan Speed	MONITOR	Controller Faults	MONITOR
Fan Amperage	MONITOR	Fan Faults	MONITOR
Fan Power	MONITOR	Fan Status	MONITOR
VFD Faults	MONITOR	PCU Faults	MONITOR
Controller Faults	MONITOR	PCU Filter Clog Percentages	MONITOR
Fan Faults	MONITOR	Fire Condition	MONITOR
Fan Status	MONITOR	CORE Fire System	MONITOR
PCU Faults	MONITOR	Building Pressures	MONITOR
PCU Filter Clog Percentages	MONITOR	Fans Button(s)	MONITOR & CONTROL
Fire Condition	MONITOR	Lights Button(s)	MONITOR & CONTROL
CORE Fire System	MONITOR	Wash Button	MONITOR & CONTROL
Building Pressures	MONITOR		
Prep Time Button	MONITOR & CONTROL		
Fans Button	MONITOR & CONTROL		
Lights Button	MONITOR & CONTROL		
Wash Button	MONITOR & CONTROL		

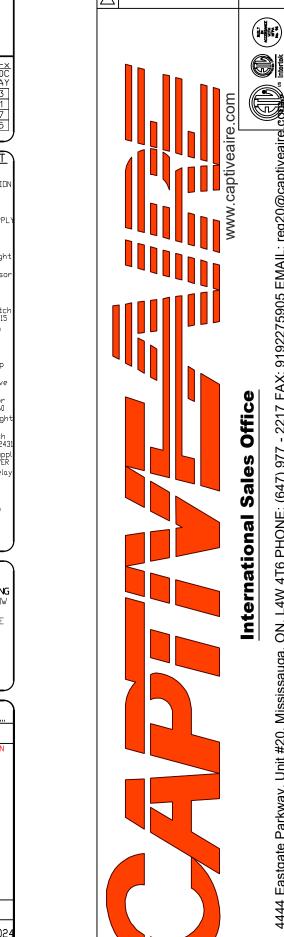

REVISIONS
DESCRIPTION DATE:


Neshama Hospice R3
25 Brightwood Street
Toronto, DN, M3H 2Z7

SCALE:

3/4" = 1'-0"

MASTER DRAWING

7179537

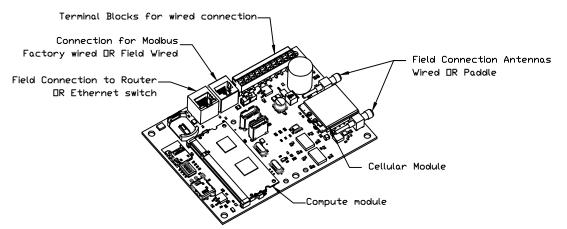


# CASlink Monitor and Control

- Hood control panel to support communications to cloud-based Building Management System.
   Hood Control Panel to allow cloud-based Building Management System to monitor real time parameters outlined as MONITOR in the points list.
   Hood Control Panel to allow cloud-based Building Management System to control parameters outlined as CONTROL in the points list.
   Hood Control Panel to allow cloud-based Building Management System to implement SYSTEM ECONOMIZER control strategies for fully integrated Building Management.

# MONITORING AND CONTROL POINTS LIST

DCV Packages	Function	SC Packages	Function
Room Temperature	MONITOR	Room Temperature(s)	MONITOR
Duct Temperature(s)	MONITOR	Duct Temperature(s)	MONITOR
MUA Discharge Temperature	MONITOR	MUA Discharge Temperature	MONITOR
Kitchen RTU Discharge Temperature	MONITOR	Kitchen RTU Discharge Temperature	MONITOR
Fan Speed	MONITOR	Controller Faults	MONITOR
Fan Amperage	MONITOR	Fan Faults	MONITOR
Fan Power	MONITOR	Fan Status	MONITOR
VFD Faults	MONITOR	PCU Faults	MONITOR
Controller Faults	MONITOR	PCU Filter Clog Percentages	MONITOR
Fan Faults	MONITOR	Fire Condition	MONITOR
Fan Status	MONITOR	CORE Fire System	MONITOR
PCU Faults	MONITOR	Building Pressures	MONITOR
PCU Filter Clog Percentages	MONITOR	Fans Button(s)	MONITOR & CONTROL
Fire Condition	MONITOR	Lights Button(s)	MONITOR & CONTROL
CORE Fire System	MONITOR	Wash Button	MONITOR & CONTROL
Building Pressures	MONITOR		
Prep Time Button	MONITOR & CONTROL		
Fans Button	MONITOR & CONTROL		
Lights Button	MONITOR & CONTROL		
Wash Button	MONITOR & CONTROL		


JOB NO 7170527	MODEL NUMBER SC-310110MA	DF	RAWN BY	SCHEMATIC TYPE INSTALL	DESCRIPTION OF 3 Phase w/ control for 1 E	DPERATION:	on in Fire, Lights out in Fire, Relay Or	∕Off with Supply Fan, F
7179537	JOB NAME Neshama Hospice R3		ATE 11/20/2024	DWG NO ECP #2-1	On/Off Thermostatically Con PHASE MOTOR REQUIRED FOR U	itrolled. Room tempei JSE WITH VFD.	on in Fire, Lights out in Fire, Relay Or rature sensor shipped loose for field i	nstallation. INVERTER DI
1  BREAKER PANEL TO PRIMARY Responsibility: Elect 3 BREAKER SIZE SHOWN IS THE M	CUNTRUL PANEL  rician  ROOM	TEMP SENSOR	J CONTROL BOARD. IN ROOM AWAY FR	INSTALL ROOM  THEAT GROUN	IPS:	Respon	. PANEL TO FIRE SYST sibility: ALARM CONTRACTO	२
BREAKER PANEL	PRIMARY CONTROL PANEL	ON THE	S. DO NOT INSTALL CEILING GRID, SEE	MANUAL.	C	ONTROL PANEL		COMPONENT  BUILDING
BREAKER 1PH  120 V  15 A CONTROL POWER. DO NO TO GFCI OR SHUNT TRIP BREAKER.			J CONTROL BOARD. MOUNTED IN HOOD	CAPTURE CAPTU	JRE 1 SIG BU FIR	ROL PANEL  NAL FOR  JILDING  E ALARM	AL1  AL2  WIRE DIRECTLY TO CORE CIRCUIT	ALARM PANEL FIRE INPUT
S IST HOOD LIGHT BREAKER SHAREI CONTROL POWER. SWITCH #1  BREAKER 3PH 208 V MCA: 6.8 A	LINE		HOT TO GAS ENERGIZED THROU HEN FIRE SYSTEN	S VALVE NEUTRAL	CONT	PANEL  ROL PANEL  NAL FOR  JILDING TBC O	BOARD. AL1 WILL MAKE AL2 IN FIRE CONDITION.	BUIL DING ALARM PANEL
EXH-2 SM-1 wire to VFD QUICK CONNECT	JR CONTROL	REQUIF	FOLLOWING CONNE MAY OR MAY NOT RED BASED ON J SPECIFICATIONS HOT TO SHU	BE IBSITE SHUNT	AL	ROUBLE TBL O-	NIRMALLY CLOSED TROUBLE RELAY CONTACTS WILL MAKE TBC TO TBL IN TROUBLE CONDITION.	
CONTROL PANEL TO Responsibility: Elect	FANS EXTE	RNAL ST TER	EUTRAL FROM SHO RMINAL IS ENERG E CONDITION.	IZED			PANEL TO FIRE SYST bility: CERTIFIED INSTALL	
PRIMARY PANEL  Load Wiring U1 - LOAD LEG 1	FAN: 02 EXH-2 SIGNA	L FOR N1 O NEUT	HOT_TO_CONTAC TRAL_TO_CONTAC RMINAL IS DE-EN E CONDITION.	DR_COIL	R_CDILL	21 <del>©</del> -		FIRE STATS
WIRE TO WI LOAD LEG 3  VFD QUICK GNDC  CONNECTOR  MUST HAVE ITS OWN  DO NOT SHARE COND	VOLT: 208 V  VOLT: 208 V  VOLT: 208 V  VOLT: 208 V  CONTROL  DRY CI  DN/OFF  SUPPL	_ PANEL SFC 0	NORMAL NORMAL	COMMON LY OPEN COMMON LY OPEN	MDL D	ITROL PANEL TO DUCT UNTED FIRE ETECTION STAT(S)	FIRE STAT SUPERVISED LOOP May be mixed factory and field wiring. See Installation Schematic. Multiple fire sensors possible. HIGH TEMP WIRE (842 F), PN: SLPCON-xFT required for all Supervised Loop wiring in contact with a hood. All other wiring shal be PN: 6320UL, Belden or similar.	FS-01  Fire Stat  FS-02  BK WH
· . CONTROL PANEL TO ACCE: ·		CDMMDN	ONTACTS WILL MAI TO NORMALLY OPEI JPPLY FAN IS ON.	BMS SW		24 ® - 		PULL STATION
CONTROL PANEL	COMPONENT CONTROL	PANEL HI O	SWITCH THROUGH			10200	MANUAL ACTUATION LOOP / REMOTE FIRE SYSTEM LOOP. Multiple manual actuation possible.	MS-01   C ND Micro SW
CONTROL PANEL TO SWITCHES  ALL SWITCHES FACTORY CAT-5 CONNECTION	WIRED SWI	TCH LIGHTS	CTIVATE Z⊡NE1 F	GAS SOL	LENDID SYS	ROL PANEL O FIRE TEM PULL	Multiple manual actuation possible.  A Plug jumper with wires from pin1 to pin4 and from pin2 to pin3 is mounted or J10, remove the jumpers and wire in the supervised actuation loop. Microswitch MS-01 is optional for fire system interlock.	Adjacent FS
CONTROL PANEL B1 O O O O O O O O O O O O O O O O O O		NIDO ONLY E	ENERGIZED THROU HEN FIRE SYSTEN NEEDED IF USING	EGATIVE IGH LCD I ARMED.		TATION	Auxiliary Interlock (AUX-01): Wire AUI / AU2 of adjacent Master FS panel(s) in each manual activation loop for simultaneous activation. See Fire system drawings for more information.	Panel MAD-01 COND Manual Actuation Device
COMM CAT-5 ETHERNET CONNEI CONTROL PANEL TO WIRE DIRECTLY TO COMM					CONT	ECPM03	CAT-5 CONNECTION	CORE PCB
WORLD WIDE WEB WEB WIRE DIRECTLY TO COMM MODULE. NET REQUIRES 1 UDP PORT 1444 & 1445 OUTBOUND TRAFFIC ONLY	) DHCP 2)					TO STATE OF THE PANEL	WIRE DIRECTLY TO CONTROL BOARD ADDITIONAL DEVICES MAY BE INLINE PLACE END OF LINE PLUG IN EMPTY JACK. PN: EDL120A UNLESS VFD, PCU, OR OTHER COMPONENT IN SERIES.	
-								

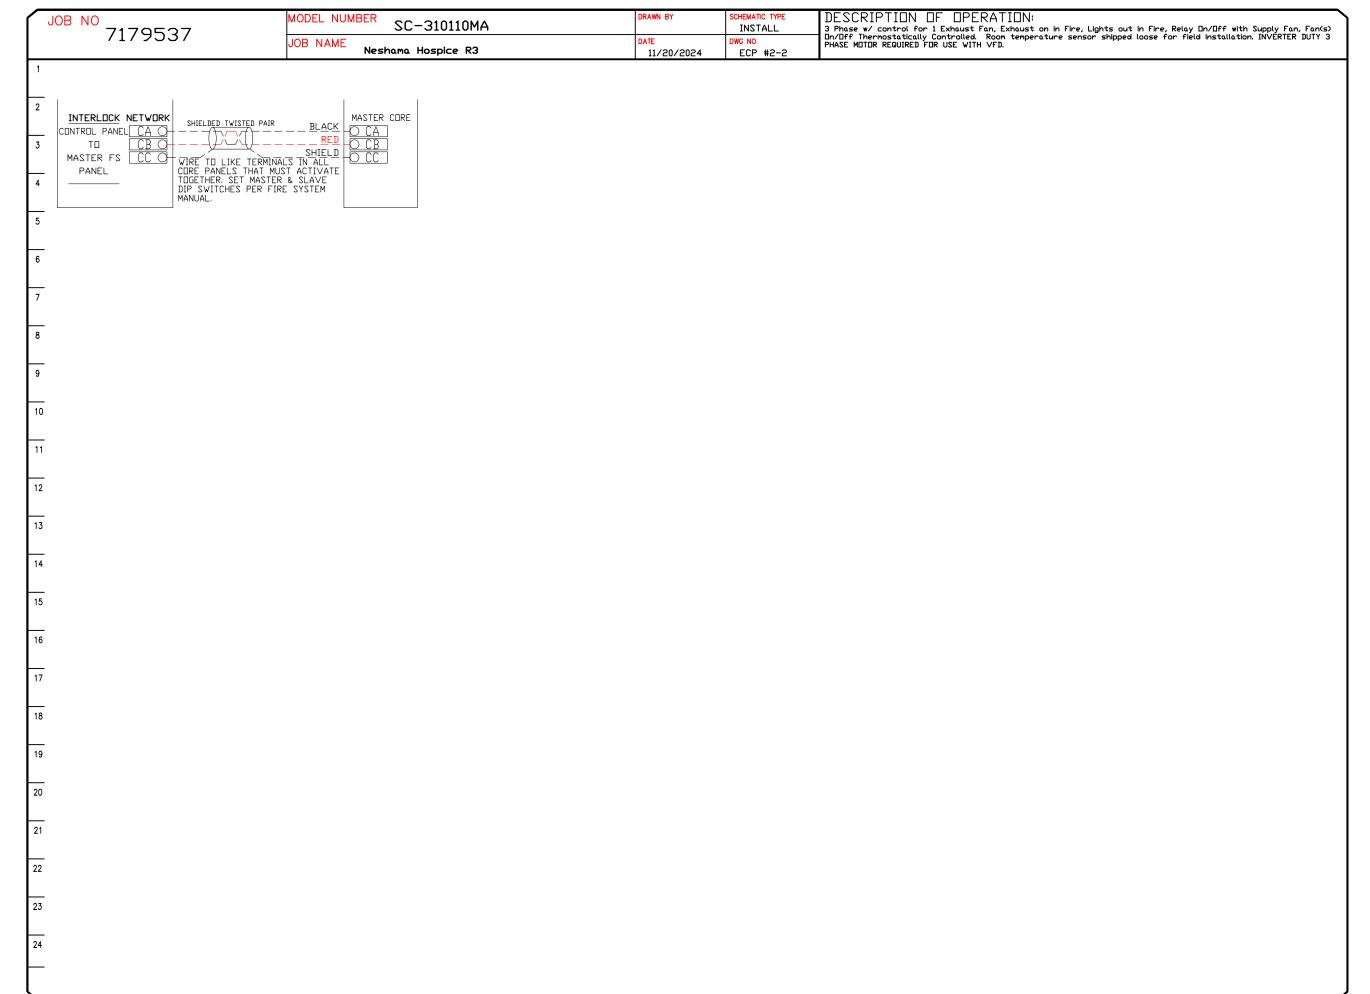


DATE: 11/20/2024  DWG.#: 7179537  DRAWN Ryan Fung SCALE: 3/4" = 1'-0"		www.captiveaire.com   International Sales Office   A444 Eastgate Parkway, Unit #20, Mississauga, ON, L4W 4T6 PHONE: (647) 977 - 2217 FAX: 9192275905 EMAIL: reg20@captiveaire.com   A444 Eastgate Parkway, Unit #20, Mississauga, ON, L4W 4T6 PHONE: (647) 977 - 2217 FAX: 9192275905 EMAIL: reg20@captiveaire.com   A444 Eastgate Parkway, Unit #20, Mississauga, ON, L4W 4T6 PHONE: (647) 977 - 2217 FAX: 9192275905 EMAIL: reg20@captiveaire.com   A444 Eastgate Parkway, Unit #20, Mississauga, ON, L4W 4T6 PHONE: (647) 977 - 2217 FAX: 9192275905 EMAIL: reg20@captiveaire.com   A444 Eastgate Parkway, Unit #20, Mississauga, ON, L4W 4T6 PHONE: (647) 977 - 2217 FAX: 9192275905 EMAIL: reg20@captiveaire.com   A444 Eastgate Parkway, Unit #20, Mississauga, ON, L4W 4T6 PHONE: (647) 977 - 2217 FAX: 9192275905 EMAIL: reg20@captiveaire.com   A444 Eastgate Parkway, Unit #20, Mississauga, ON, L4W 4T6 PHONE: (647) 977 - 2217 FAX: 9192275905 EMAIL: reg20@captiveaire.com   A444 Eastgate Parkway, Unit #20, Mississauga, ON, L4W 4T6 PHONE: (647) 977 - 2217 FAX: 9192275905 EMAIL: reg20@captiveaire.com   A444 Eastgate Parkway, Unit #20, Mississauga, ON, L4W 4T6 PHONE: (647) 977 - 2217 FAX: 9192275905 EMAIL: reg20@captiveaire.com   A444 Eastgate Parkway, Unit #20, Mississauga, ON, L4W 4T6 PHONE: (647) 977 - 2217 FAX: 9192275905 EMAIL: reg20@captiveaire.com   A444 Eastgate Parkway, Unit #20, Mississauga, ON, L4W 4T6 PHONE: (647) 977 - 2217 FAX: 9192275905 EMAIL: reg20@captiveaire.com   A444 Eastgate Parkway, Unit #20, Mississauga, ON, L4W 4T6 PHONE: (647) 977 - 2217 FAX: 9192275905 EMAIL: reg20@captiveaire.com   A444 Eastgate PAX: 9
<b>DRAWN BY:</b> Ryan Fung	Neshama Hospice R Table A  DMG**	Toronto,
CANIE.	DRAWN BY: Ryan	Fung

SHEET NO.

**REVISIONS** 

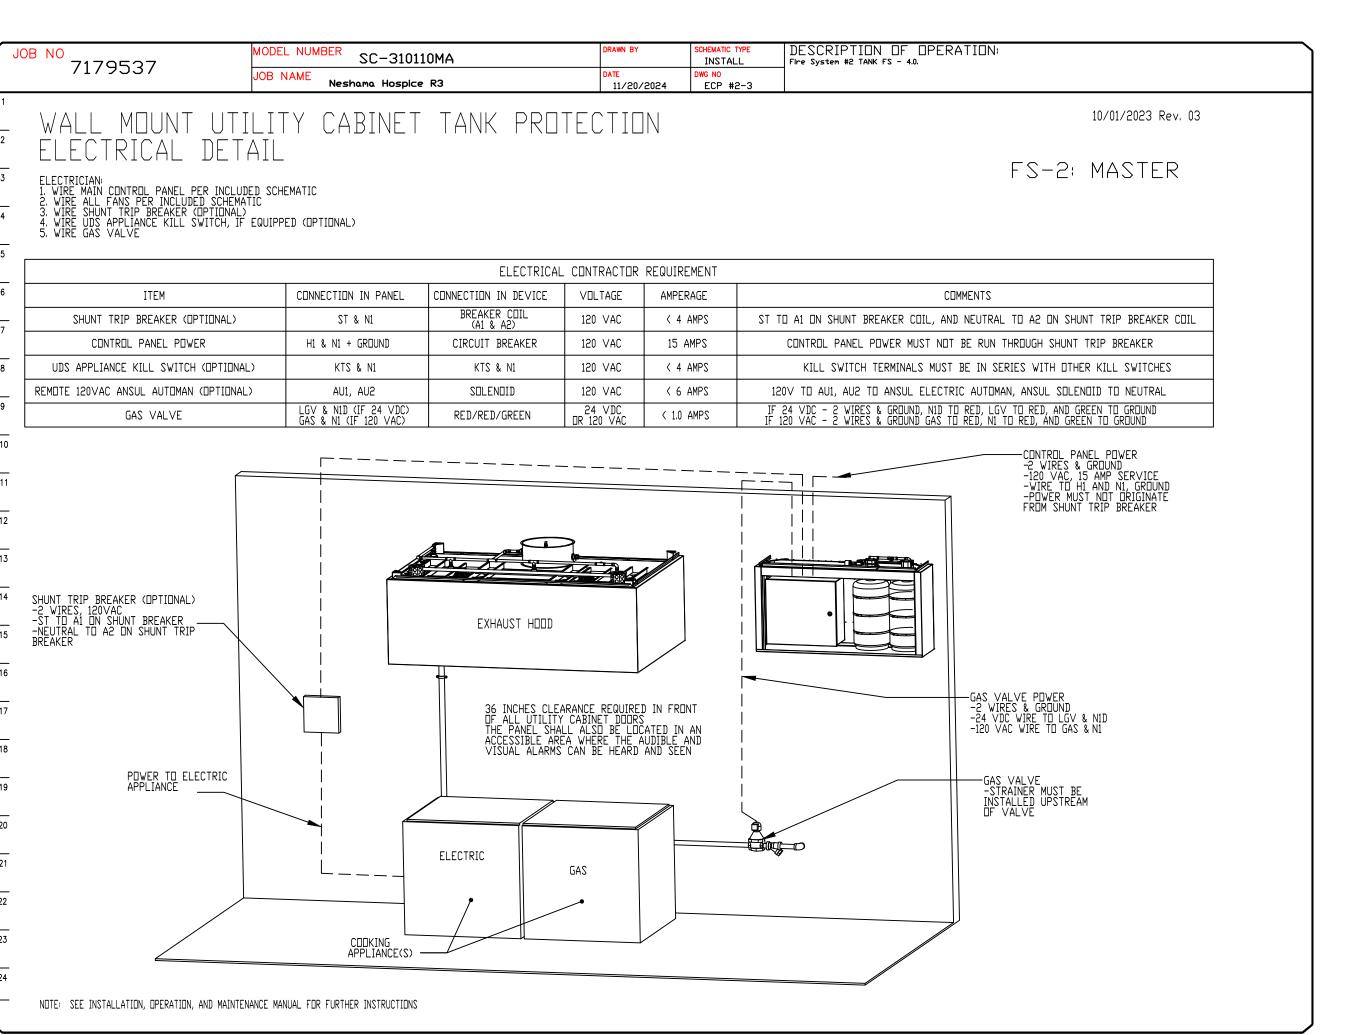

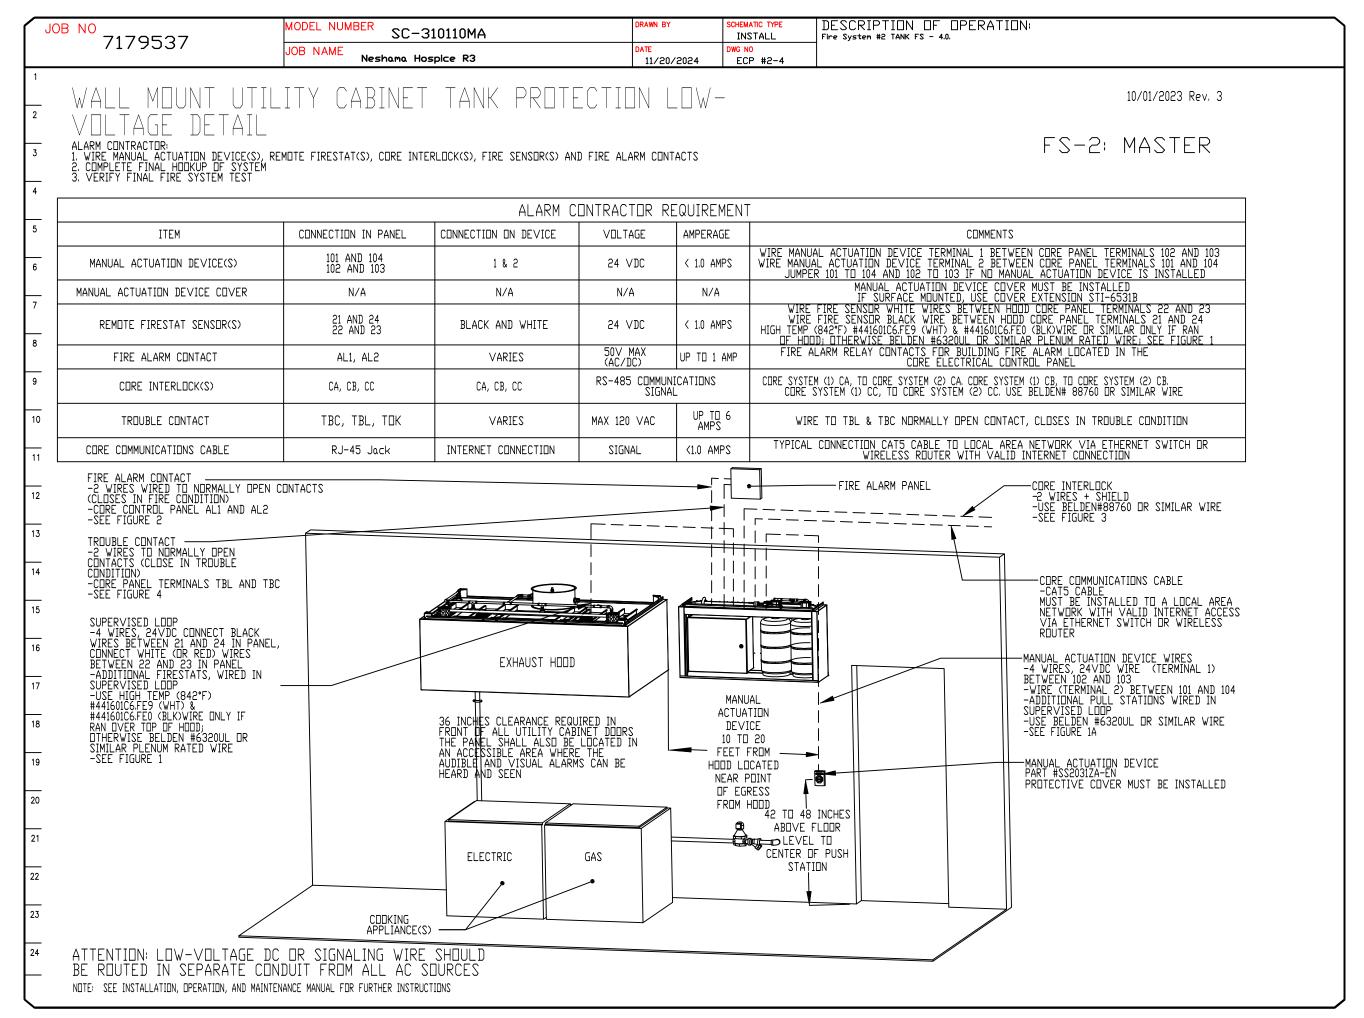



**REVISIONS** 

Neshama Hospice R3
25 Brightwood Street,
Toronto, DN, M3H 227

DATE: 11/20/2024

DWG.#:


7179537


DRAWN Ryan Fung

**SCALE:** 3/4" = 1'-0"

MASTER DRAWING

SHEET NO.

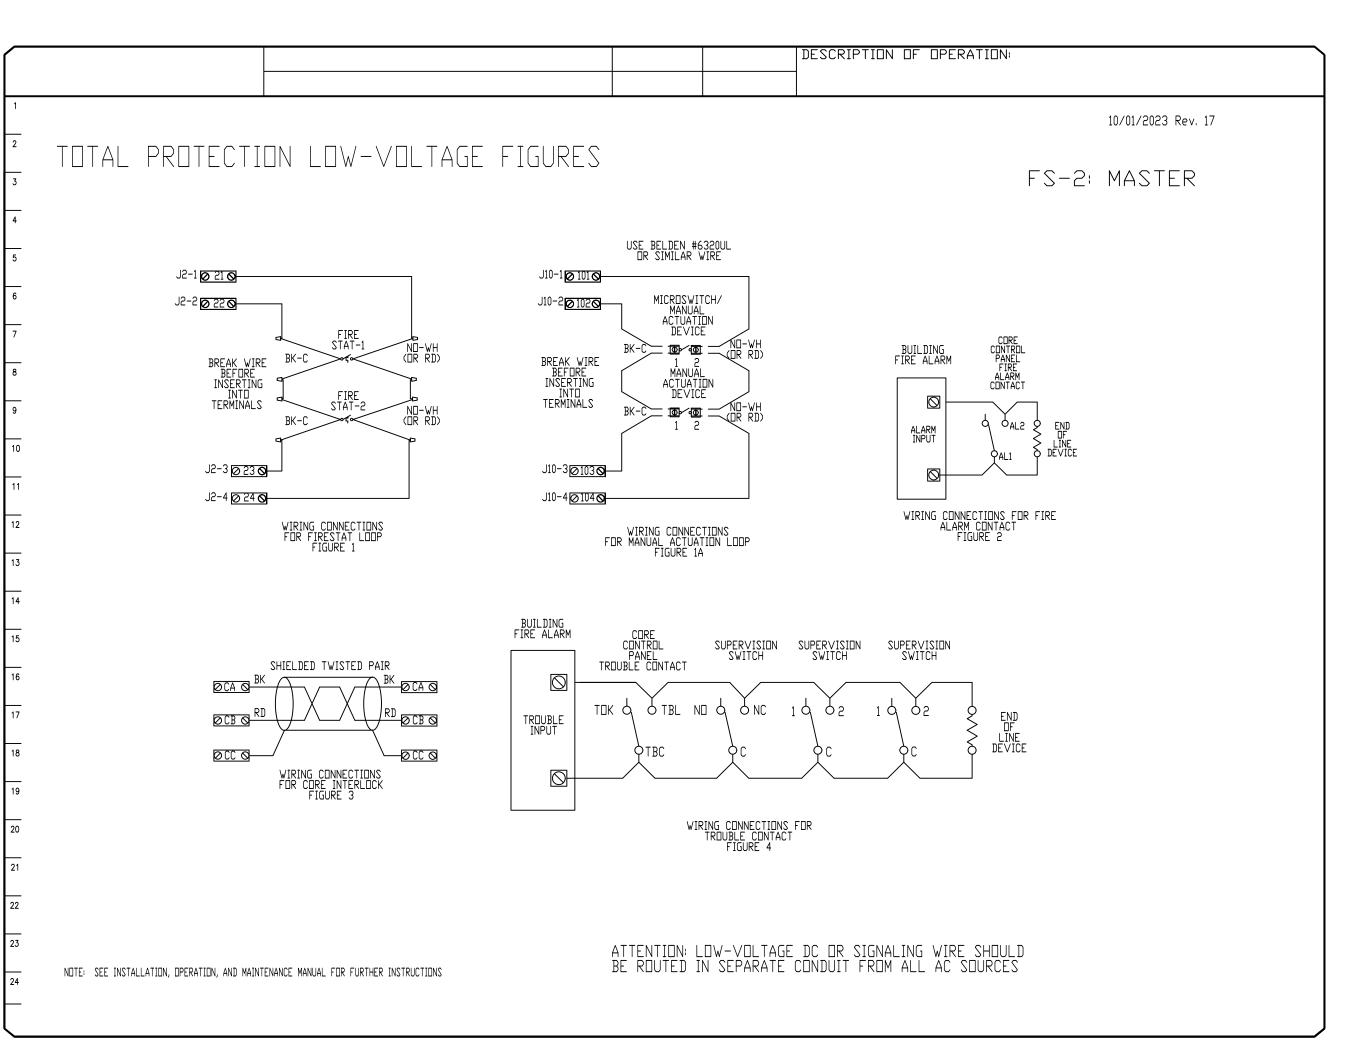

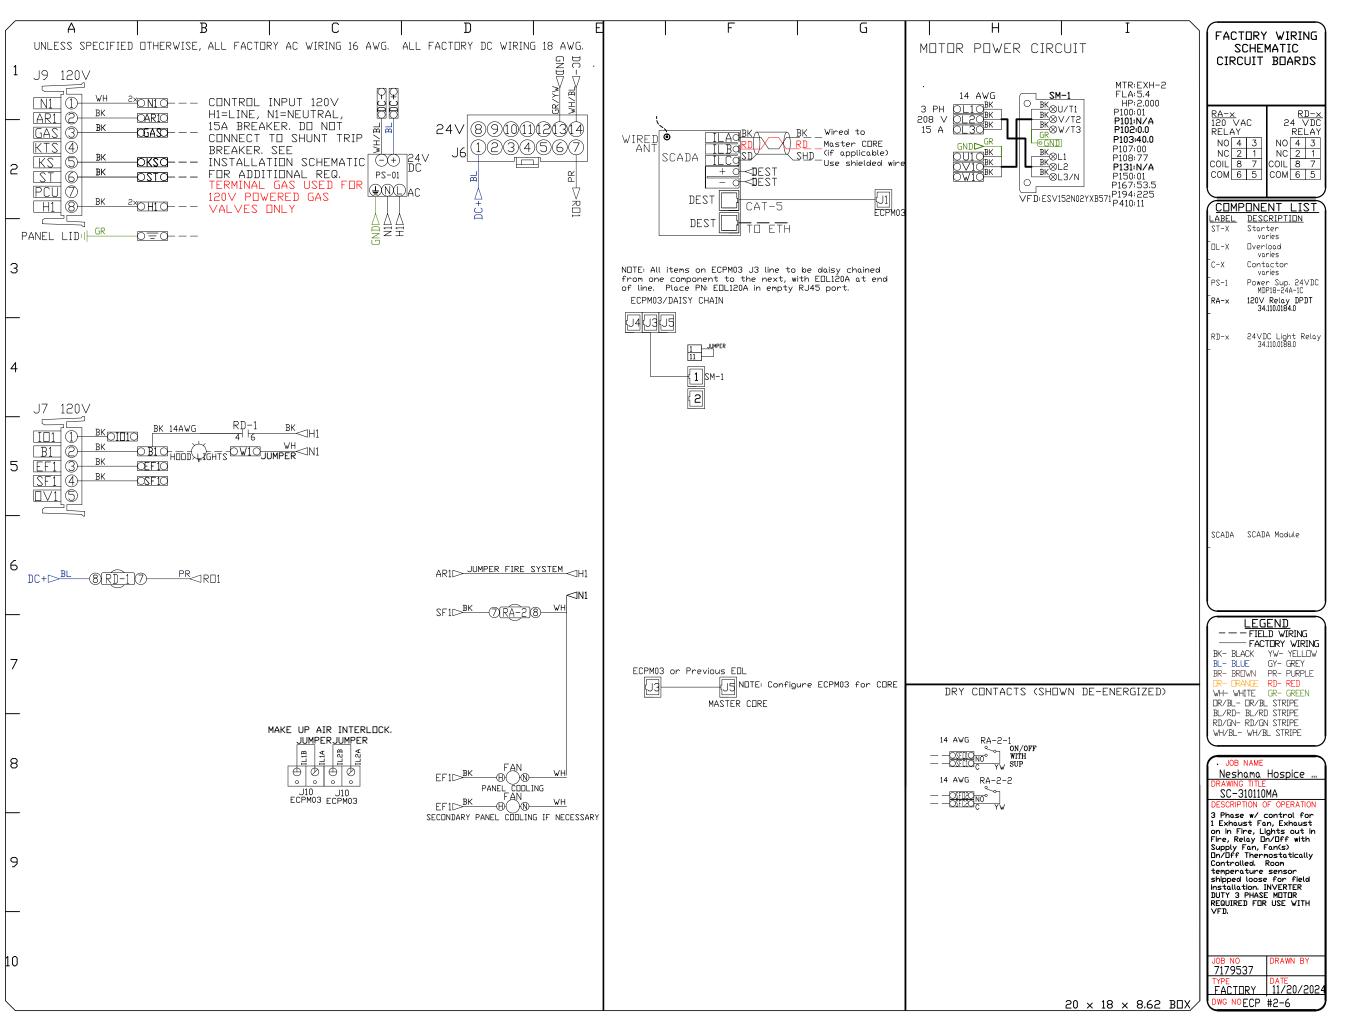



**REVISIONS** DESCRIPTION DATE:

Hospice \$ wood Z Brigh 0 N 7


Neshama **DATE:** 11/20/2024 DWG.#:

7179537 **DRAWN BY:** Ryan Fung

**SCALE:** 3/4" = 1'-0"

**MASTER DRAWING** 

SHEET NO.

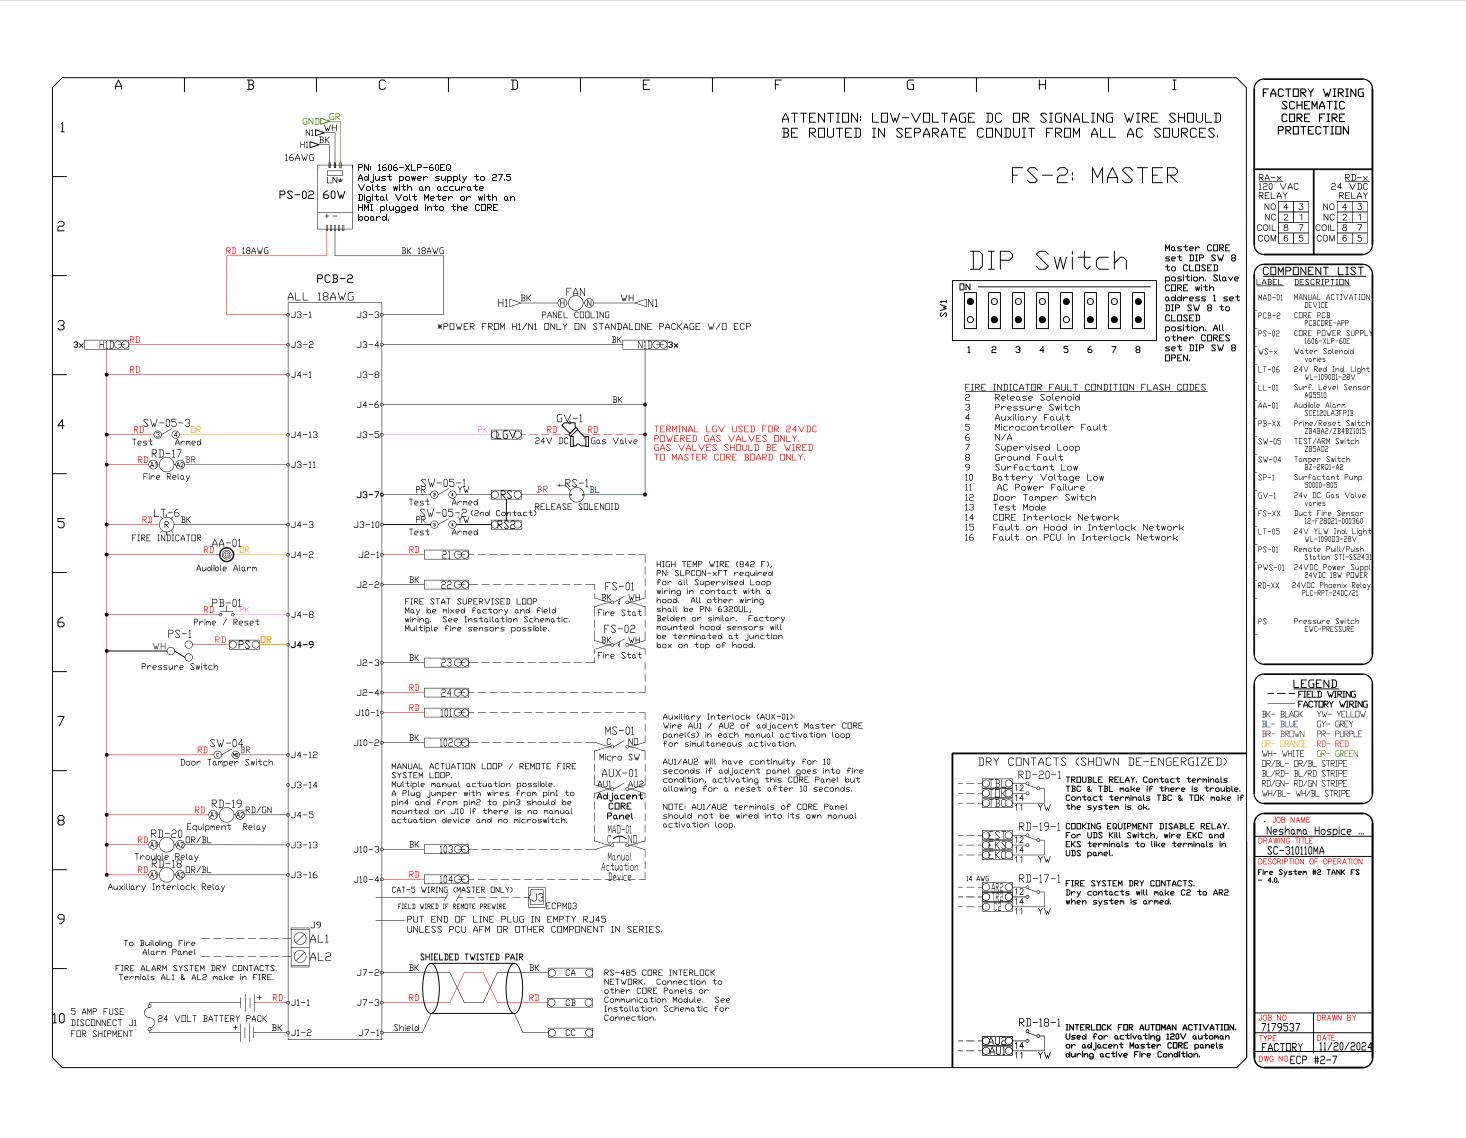

International Sales Office

4444 Eastgate Parkway, Unit #20, Mississauga, ON, L4W 4T6 PHONE: (647) 977 - 2217 FAX: 9192275905 EMAIL: reg20@captiveaire.com

REVISIONS

DESCRIPTION DATE:

Neshama Hospice R3 25 Brightwood Street, Toronto, DN, M3H 227

DATE: 11/20/2024

DWG.#:

7179537

DRAWN Ryan Fung

**SCALE:** 3/4" = 1'-0"

3/4" = 1'-0"

MASTER DRAWING

SHEET NO.

# SYSTEM DESIGN VERIFICATION (SDV)

IF ORDERED, CAS SERVICE WILL PERFORM A SYSTEM DESIGN VERIFICATION (SDV) ONCE ALL EQUIPMENT HAS HAD A COMPLETE START UP PER THE OPERATION AND INSTALLATION MANUAL. TYPICALLY, THE SDV WILL BE PERFORMED AFTER ALL INSPECTIONS ARE COMPLETE.

ANY FIELD RELATED DISCREPANCIES THAT ARE DISCOVERED DURING THE SDV WILL BE BROUGHT TO THE

ATTENTION OF THE GENERAL CONTRACTOR AND CORRESPONDING TRADES ON SITE. THESE ISSUES WILL BE DOCUMENTED AND FORWARDED TO THE APPROPRIATE SALES OFFICE. IF CAS SERVICE HAS

RESOLVE A DISCREPANCY THAT IS A FIELD ISSUE, THE GENERAL CONTRACTOR WILL BE NOTIFIED AND BILLED FOR THE WORK, SHOULD A RETURN TRIP BE REQUIRED DUE TO ANY FIELD RELATED DISCREPANCY THAT CANNOT BE RESOLVED DURING THE SDV, THERE WILL BE ADDITIONAL TRIP CHARGES.

DURING THE SDV, CAS SERVICE WILL ADDRESS ANY DISCREPANCY THAT IS THE FAULT OF THE MANUFACTURER. SHOULD A RETURN TRIP BE REQUIRED, THE GENERAL CONTRACTOR AND APPROPRIATE SALES OFFICE WILL BE NOTIFIED, THERE WILL BE NO ADDITIONAL CHARGES FOR MANUFACTURER DISCREPANCIES.

Hospice

**REVISIONS** DESCRIPTION DATE:

0 **DATE:** 11/20/2024

7179537

Brigh

**DRAWN BY:** Ryan Fung

**SCALE:** 3/4" = 1'-0"

**MASTER DRAWING** 

SHEET NO.