

Date of Issue: July 22, 2025 **SI-23**

Project: Saverino Phase 1 Project No.: 22-6229

556-560 Essa Road Barrie ON L4N 9E6

Permit Number: PMT20-01273

Prime Consultant: McKnight Charron Limited (MCL) Architects

General Contractor: Van Horne Construction Limited

Title: Parking Level Drainage Revision

Site instructions are issued only for the purpose of recording any clarification or interpretation of the contract documents or giving direction on problems resulting from field conditions. These instructions are subject to the provisions of the contract documents and unless otherwise stated herein and specifically authorized by the Owner, will not affect the contract. If the Contractor believes this instruction affects the Contract Price or Contract Time, a Contemplated Change Notice must be requested and a change order authorized prior to the implementation of any work outlined herein.

Instruction

It is requested that the contractor undertake the work as described below in accordance with all applicable codes and standards. Ensure all updated drawings are reviewed, including General Notes and Scope of Work, these sections contain critical information the Contractor must be aware of prior to commencing the work.

Mechanical:

The following modifications are noted on attached drawings under revision number 17.

1. Install drainage pipes for fixtures from ground floor and connect to main sanitary pipe as shown on drawings PD-102.


Issued by;

Chris Langford, P.Eng. EME Engineering, Inc.

President

chris@EMEeng.com

Attachments: PD-102

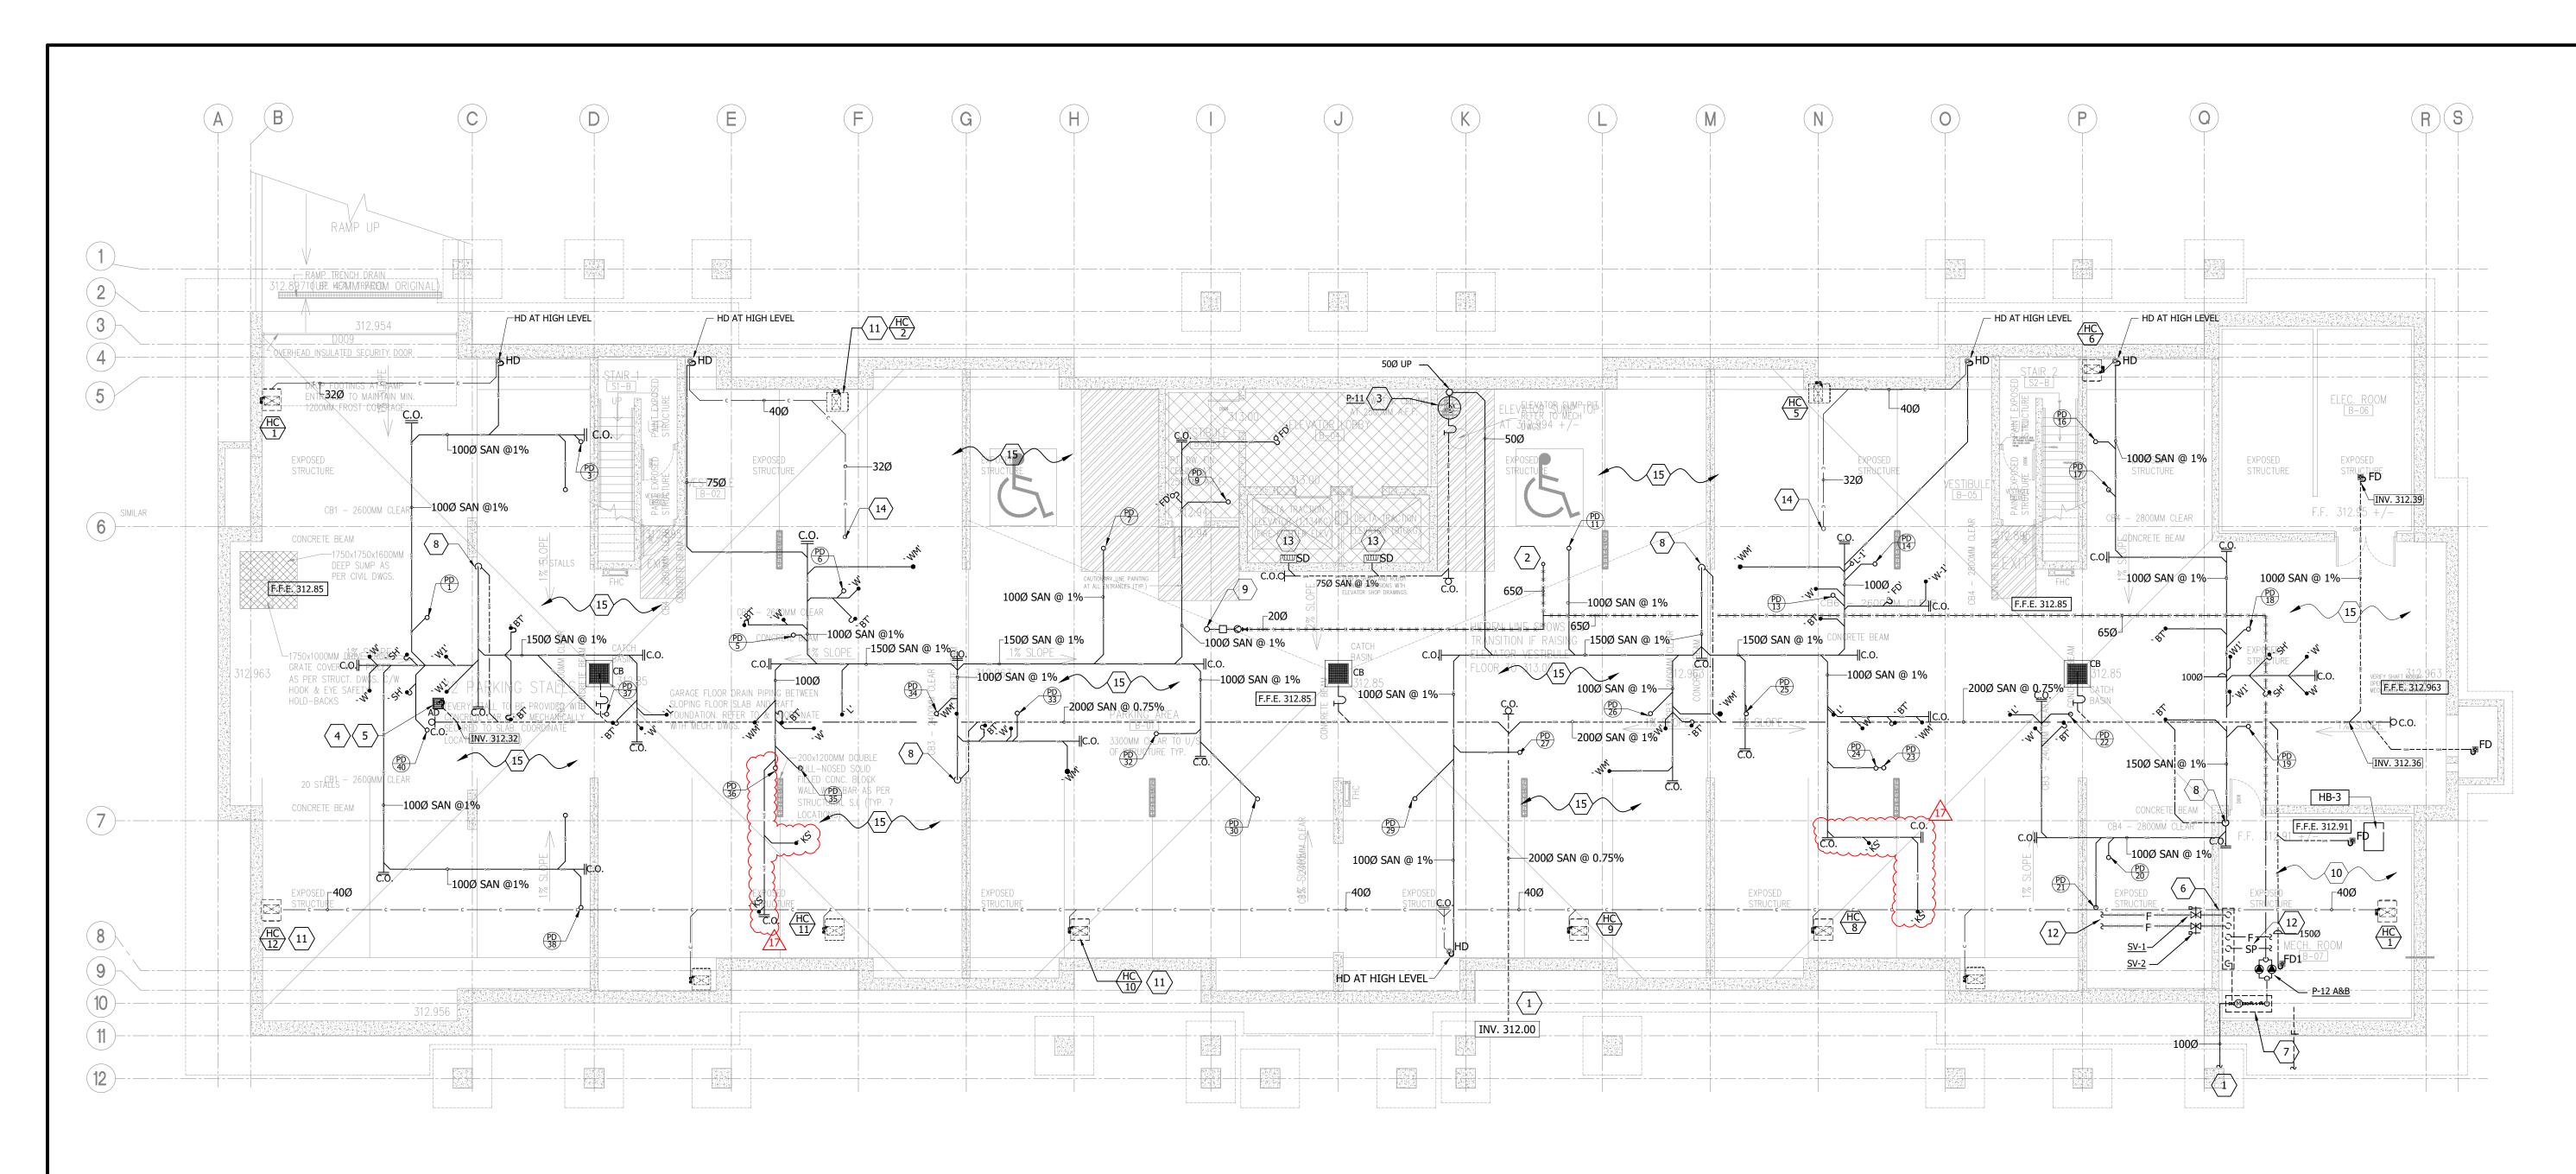

PARKING PLAN PLUMBING & DRAINAGE LAYOUT
Scale: 1:100

PARKING LEVEL PLUMBING AND DRAINAGE KEYNOTES		11	HEAT PUMP UNIT ABOVE. (TYPICAL)			
	FOR CONTINUATION AND EXACT LOCATION SEE SITE SERVICING AND GRADING PLAN PREPARED BY OTHERS.	<u></u>	FOR CONTINUATION REFER TO SPRINKLER DWG.			
2	65Ø DOMESTIC COLD WATER LINE UP.	13	ANGLE PIT DRAIN WITH BACKWATER VALVE "MIFAB" MODEL BV210.			
3	600MM Ø x 600MM BELOW ELEVATOR PIT AND PUMP P-11, SEE DETAIL ON DWG M-116.	14	32Ø CONDENSATE DRAIN LINE UP.			
4	'AD' 12-3/4" x 12-3/4", 6Ø OUTLET AREA DRAIN EQUAL C/W SEDIMENT BUCKET.	15	ALL SANITARY 'P' TRAP, WATER LINES, AND CONDENSATE LINES RUNNING WITHIN UNHEATED PARKING GARAGE SHALL BE ELECTRICALLY HEAT TRACED AND			
5	APPROXIMATE LOCATION OF 'AD' PARKING GARAGE DRAIN. FOR EXACT LOCATION REFER TO SPRINKLER DWG. PREPARED BY OTHERS.	GENE	INSULATED. ALL RECEPTACLES FOR PIPING HEAT TRACE BY DIV. 26 GENERAL NOTES:			
6	SPRINKLER STATION. FOR DETAIL REFER TO SPRINKLER DWG. PREPARED BY OTHERS.	 REFER TO "PLUMBING FIXTURE CONNECTION SCHEDULE" FOR CONNECTION SIZES. VENT ALL PLUMBING FIXTURES AS PER PROVINCIAL CODE. PROVIDE MIN 3"Ø VENT SIZE AT ROOF TERMINATION. 				
7	65Ø WATER COMPOUND METER. REFER TO WATER METER DETAIL ON DWG. M-113.	CODE	- PROVIDE BACKFLOW PREVENTER FOR KITCHEN EQUIPMENT AS REQUIRED BY PROVINCIAL			
8	SANITARY LINE DN. TO UNDER SIDE OF FLOOR SLAB	BY PR	BY PROVINCIAL CODE - EXACT LOCATION OF EXISTING SERVICES TO BE VERIFIED ON SITE BY CONTRACTOR - ALL HOT AND COLD WATER PIPING TO BE INSULATED. - EXACT ELEVATIONS, INVERTS AND SLOPES OF SANITARY AND STORM LINES TO BE DETERMINED ON SITE BY MECH. CONTRACTOR. THIS MECH. CONTRACTOR SHALL			
9	20Ø COLD WATER LINE UP. REFER TO CHUTE DETAIL ON DWG M-114.	- EXA				
10	FOR PIPING CONNECTIONS AND ARRANGEMENT REFER TO SCHEMATIC DWGS. M-111, M-112 AND M-113.	CO-OF	CO-ORDINATE EXACT TERMINATION OF SERVICES WITH LOCATION SHOWN ON DRAWING.			

JUL 22/25	17	SI-23: PARKING LEVEL DRAINAGE REVISION	AK
JUL 09/25	16	SI-22: ADJUSTMENT TO SUIT CHASE WALL	AK
JUN 16/25	15	SI-20: ROOF DRAINS REVISION	AK
JUN 12/25	14	SI-15R2: SUITES REVISION	AK
MAY 01/25	-	ISSUED FOR COORDINATION	AK
MAY 01/25	13	SI-19: ROOF DRAINS REVISION	AK
APR 14/25	12	SI-18: PLUMBING RISERS FOR SUITES REVISION	AK
MAR 11/25	11	SI-15: SUITES REVISION	AK
JAN 16/25	10	SI-13: SUITES REVISION	AK
MAY 13/24	9	SI-8: FSD CHANGES	PD
MAY 07/24	8	SI-7: GENERATOR RELOCATION	PD
SEPT 07/23	<u> </u>	SI-4: CHANGES BETWEEN IFP AND IFC	PD
MAY 24/23	_	ISSUED FOR CONSTRUCTION	PD
APR 17/23	6	RFI-52 PARKING HEATING PLENUM REMOVED	NN
APR 03/23	5	REVISED AS PER CITY COMMENTS	NN
MAR 24/23	4	REVISED AS PER CITY COMMENTS	EG
FEB 09/23	3	REVISED AS PER RFI#6	EG
SEP 01/22	2	REVISED AS PER CITY COMMENTS	JC
JUN 17/22	1	REISSUED AS PER CITY COMMENTS	EG
APR 26/22	_	ISSUED FOR PERMIT	МВ
DATE	NO.	DESCRIPTION	BY


MARK VOID ALL PRINTS DATED PREVIOUS TO FINAL DATE ABOVE

REVISIONS

CONTRACTOR MUST CHECK AND VERIFY ALL DIMENSIONS AND CONDITIONS IN THE FIELD AND REPORT ANY DISCREPANCIES TO THE ENGINEER PRIOR TO PROCEEDING WITH WORK.

THIS DRAWING IS THE PROPERTY OF THE ENGINEER AND MUST BE RETURNED UPON COMPLETION OF THE WORK. REPRODUCTION OF THIS DRAWING IS FORBIDDEN WITHOUT THE ENGINEER'S WRITTEN CONSENT.



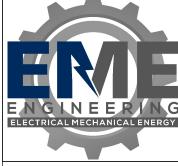

Hubbert EME Engineering

90 WINGES ROAD, SUITE 201 VAUGHAN, ON L4L 6A9 TEL: (905) 851-5492

DRAWING TITLE:

ITTE 201 67 HIGH STREET
49 BARRIE, ON L4N 1W5
TEL: (705) 735-1133
info@EMEeng.com

PROPOSED CONDOMINUM SAVERINO INVESTMENTS INC. 556-560 ESSA ROAD BARRIE, ON

PARKING LEVEL PLUMBING AND DRAINAGE

DRAWN BY:	CHECKED BY:	SCALE:	
МВ	CL	1:100	
DATE:	PROJECT NUMBER:	DRAWING NUMBER:	
APR/2022	22-6229	PD-102	